

General Purpose Warehouse

Army Standard Prototype - Climate Zone 3B 65,000 Square Foot Version Standards Submittal



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I-101	OVERALL FURNITURE PLAN	M1-401	ENLARGED HVAC FLOOR PLAN - ADMIN AREA	EP-101	ELECTRICAL POWER PLAN		

MARK	DATE	APPRO

DESIGN BY: C. Pope	DATE: 2013	CHECK BY: K. Pope	SOLICITATION NO.:
DESIGNED BY: C. Pope	PLOT DATE: 8/26/2014 1:48:59 PM	DATE:	CONTRACT NO.:
DRAWN BY: C. Pope	FILE NAME:	DATE:	FILE NUMBER:
CHECKED BY: K. Pope	FILE NAME:	DATE:	FILE NUMBER:
APPROVED BY:	FILE NAME:	DATE:	FILE NUMBER:

**GENERAL PURPOSE WAREHOUSE
PROTOTYPE DESIGN
65,000 SQUARE FOOT VERSION
COVER SHEET - CONCRETE OPTION**

**SHEET IDENTIFICATION
A2-000**
SHEET OF 0



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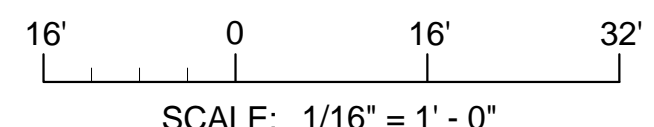
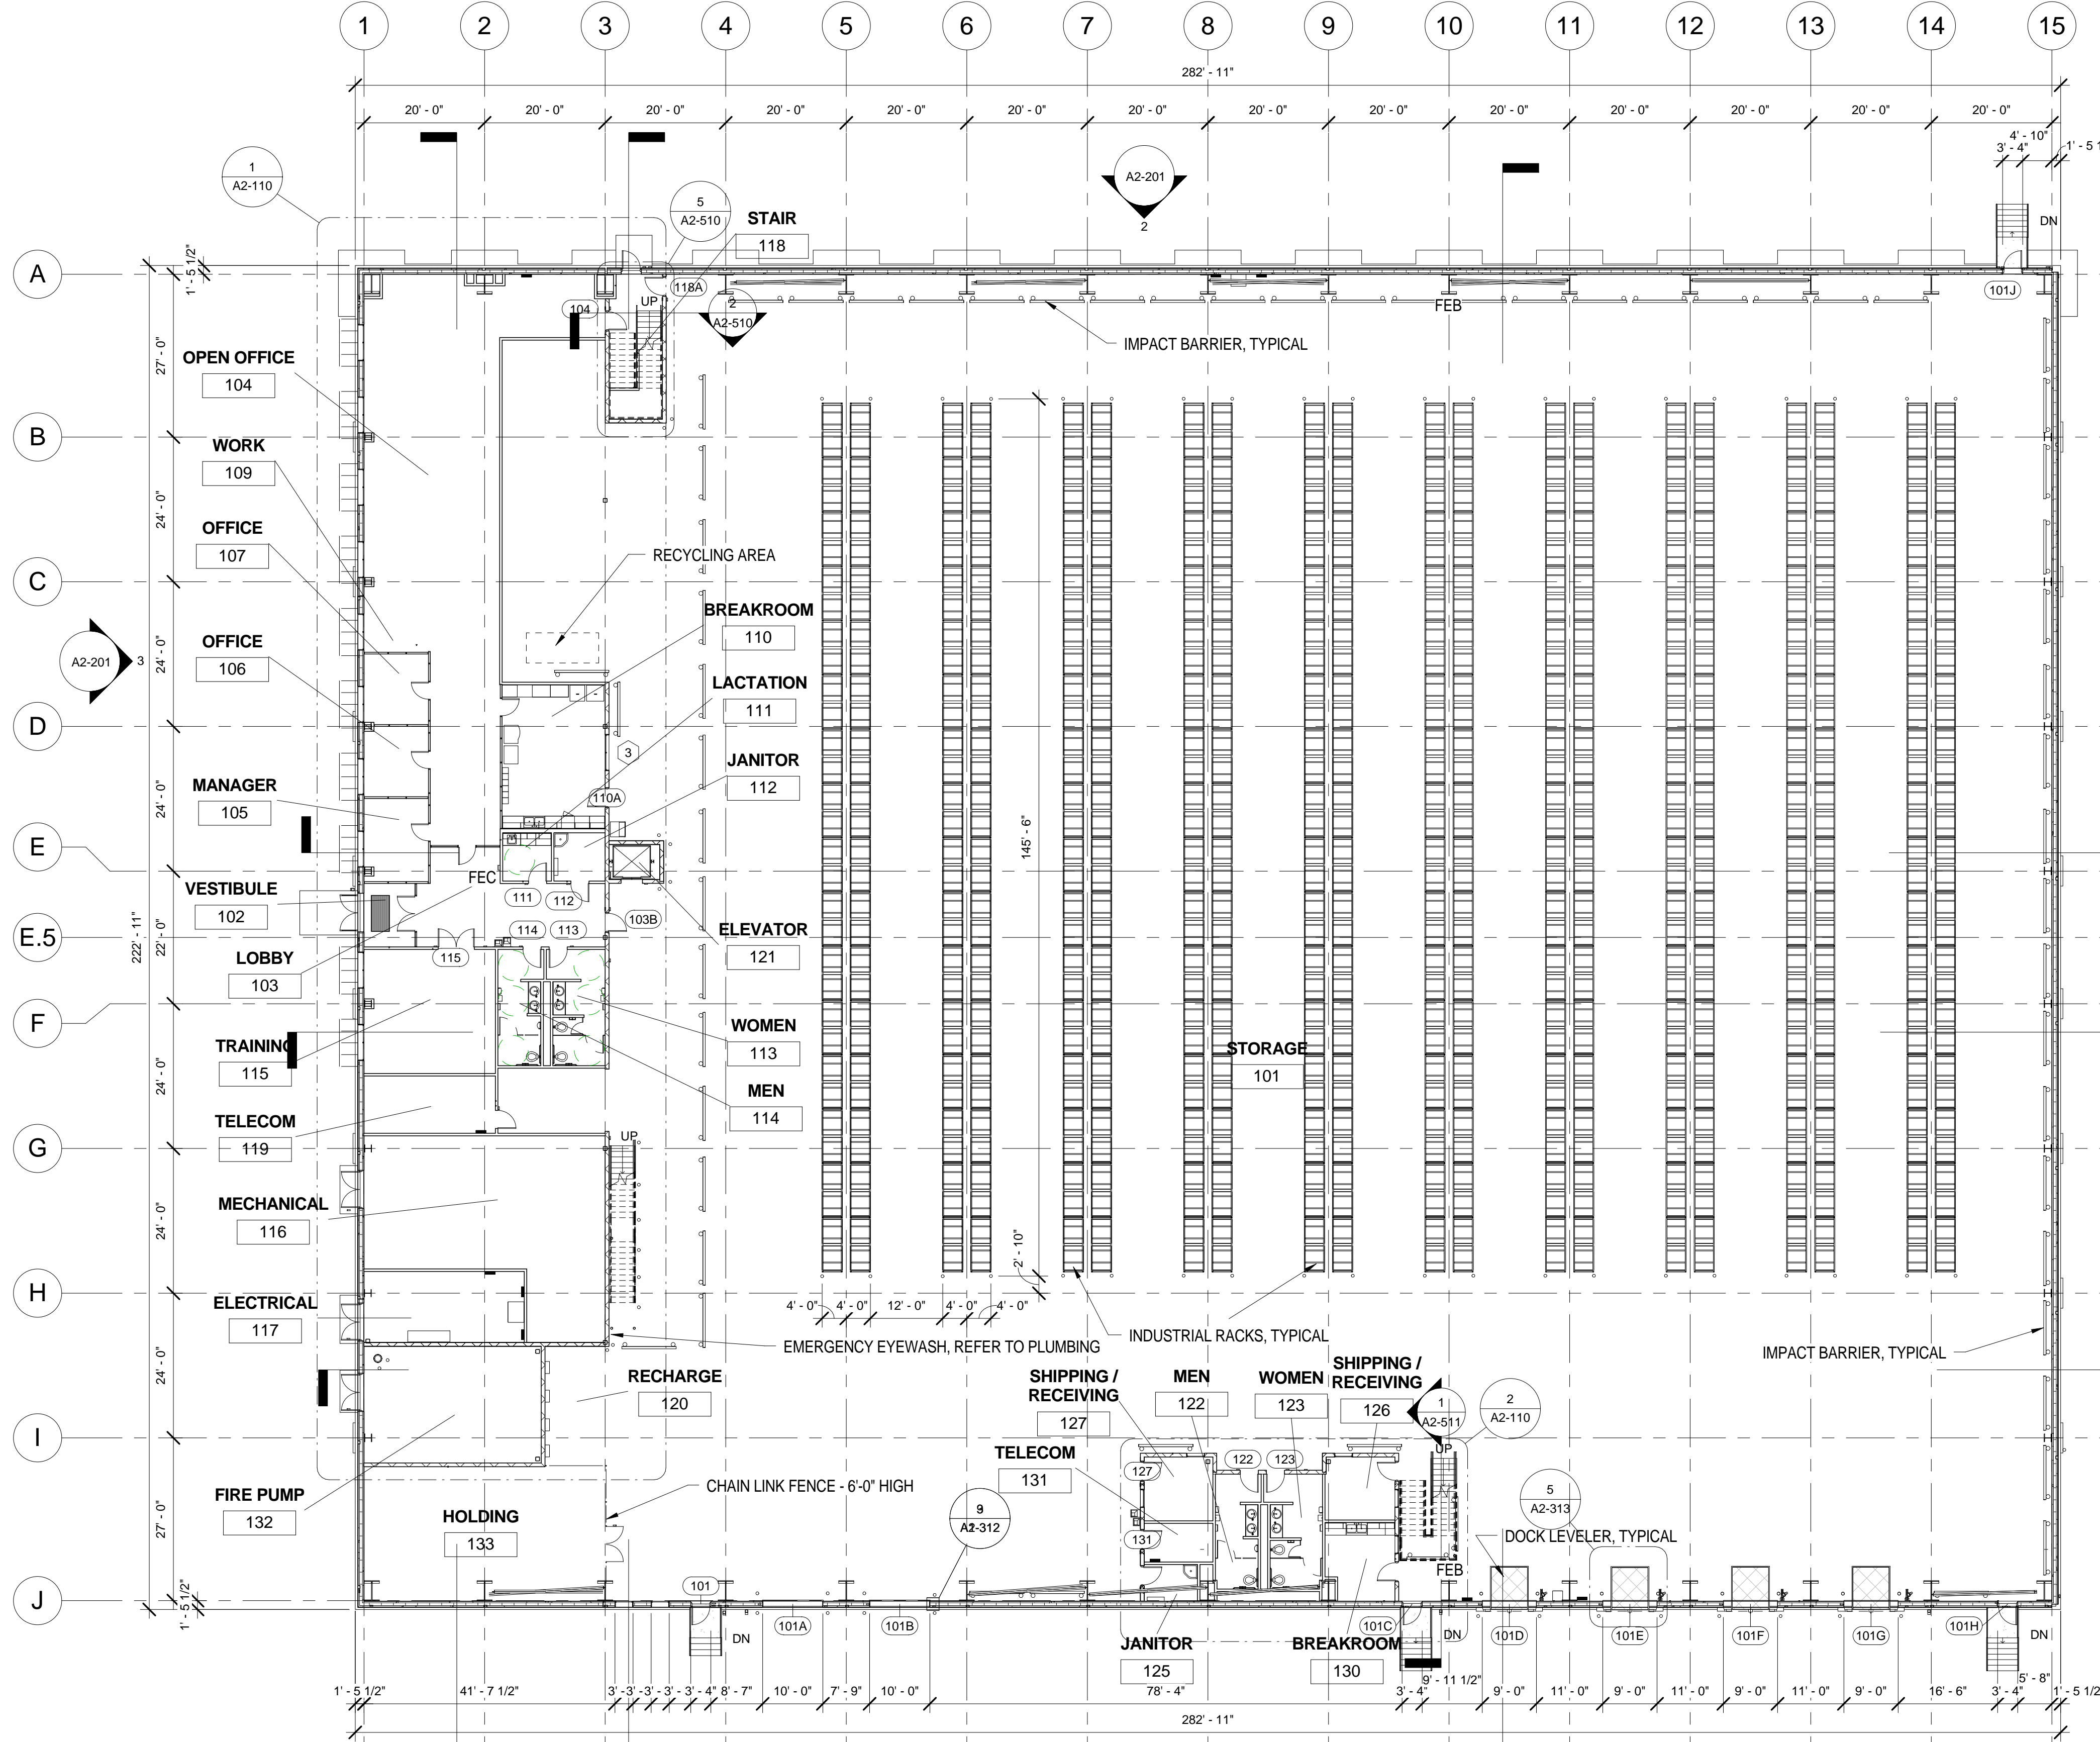
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FLOOR PLAN

1/16" = 1'-0"

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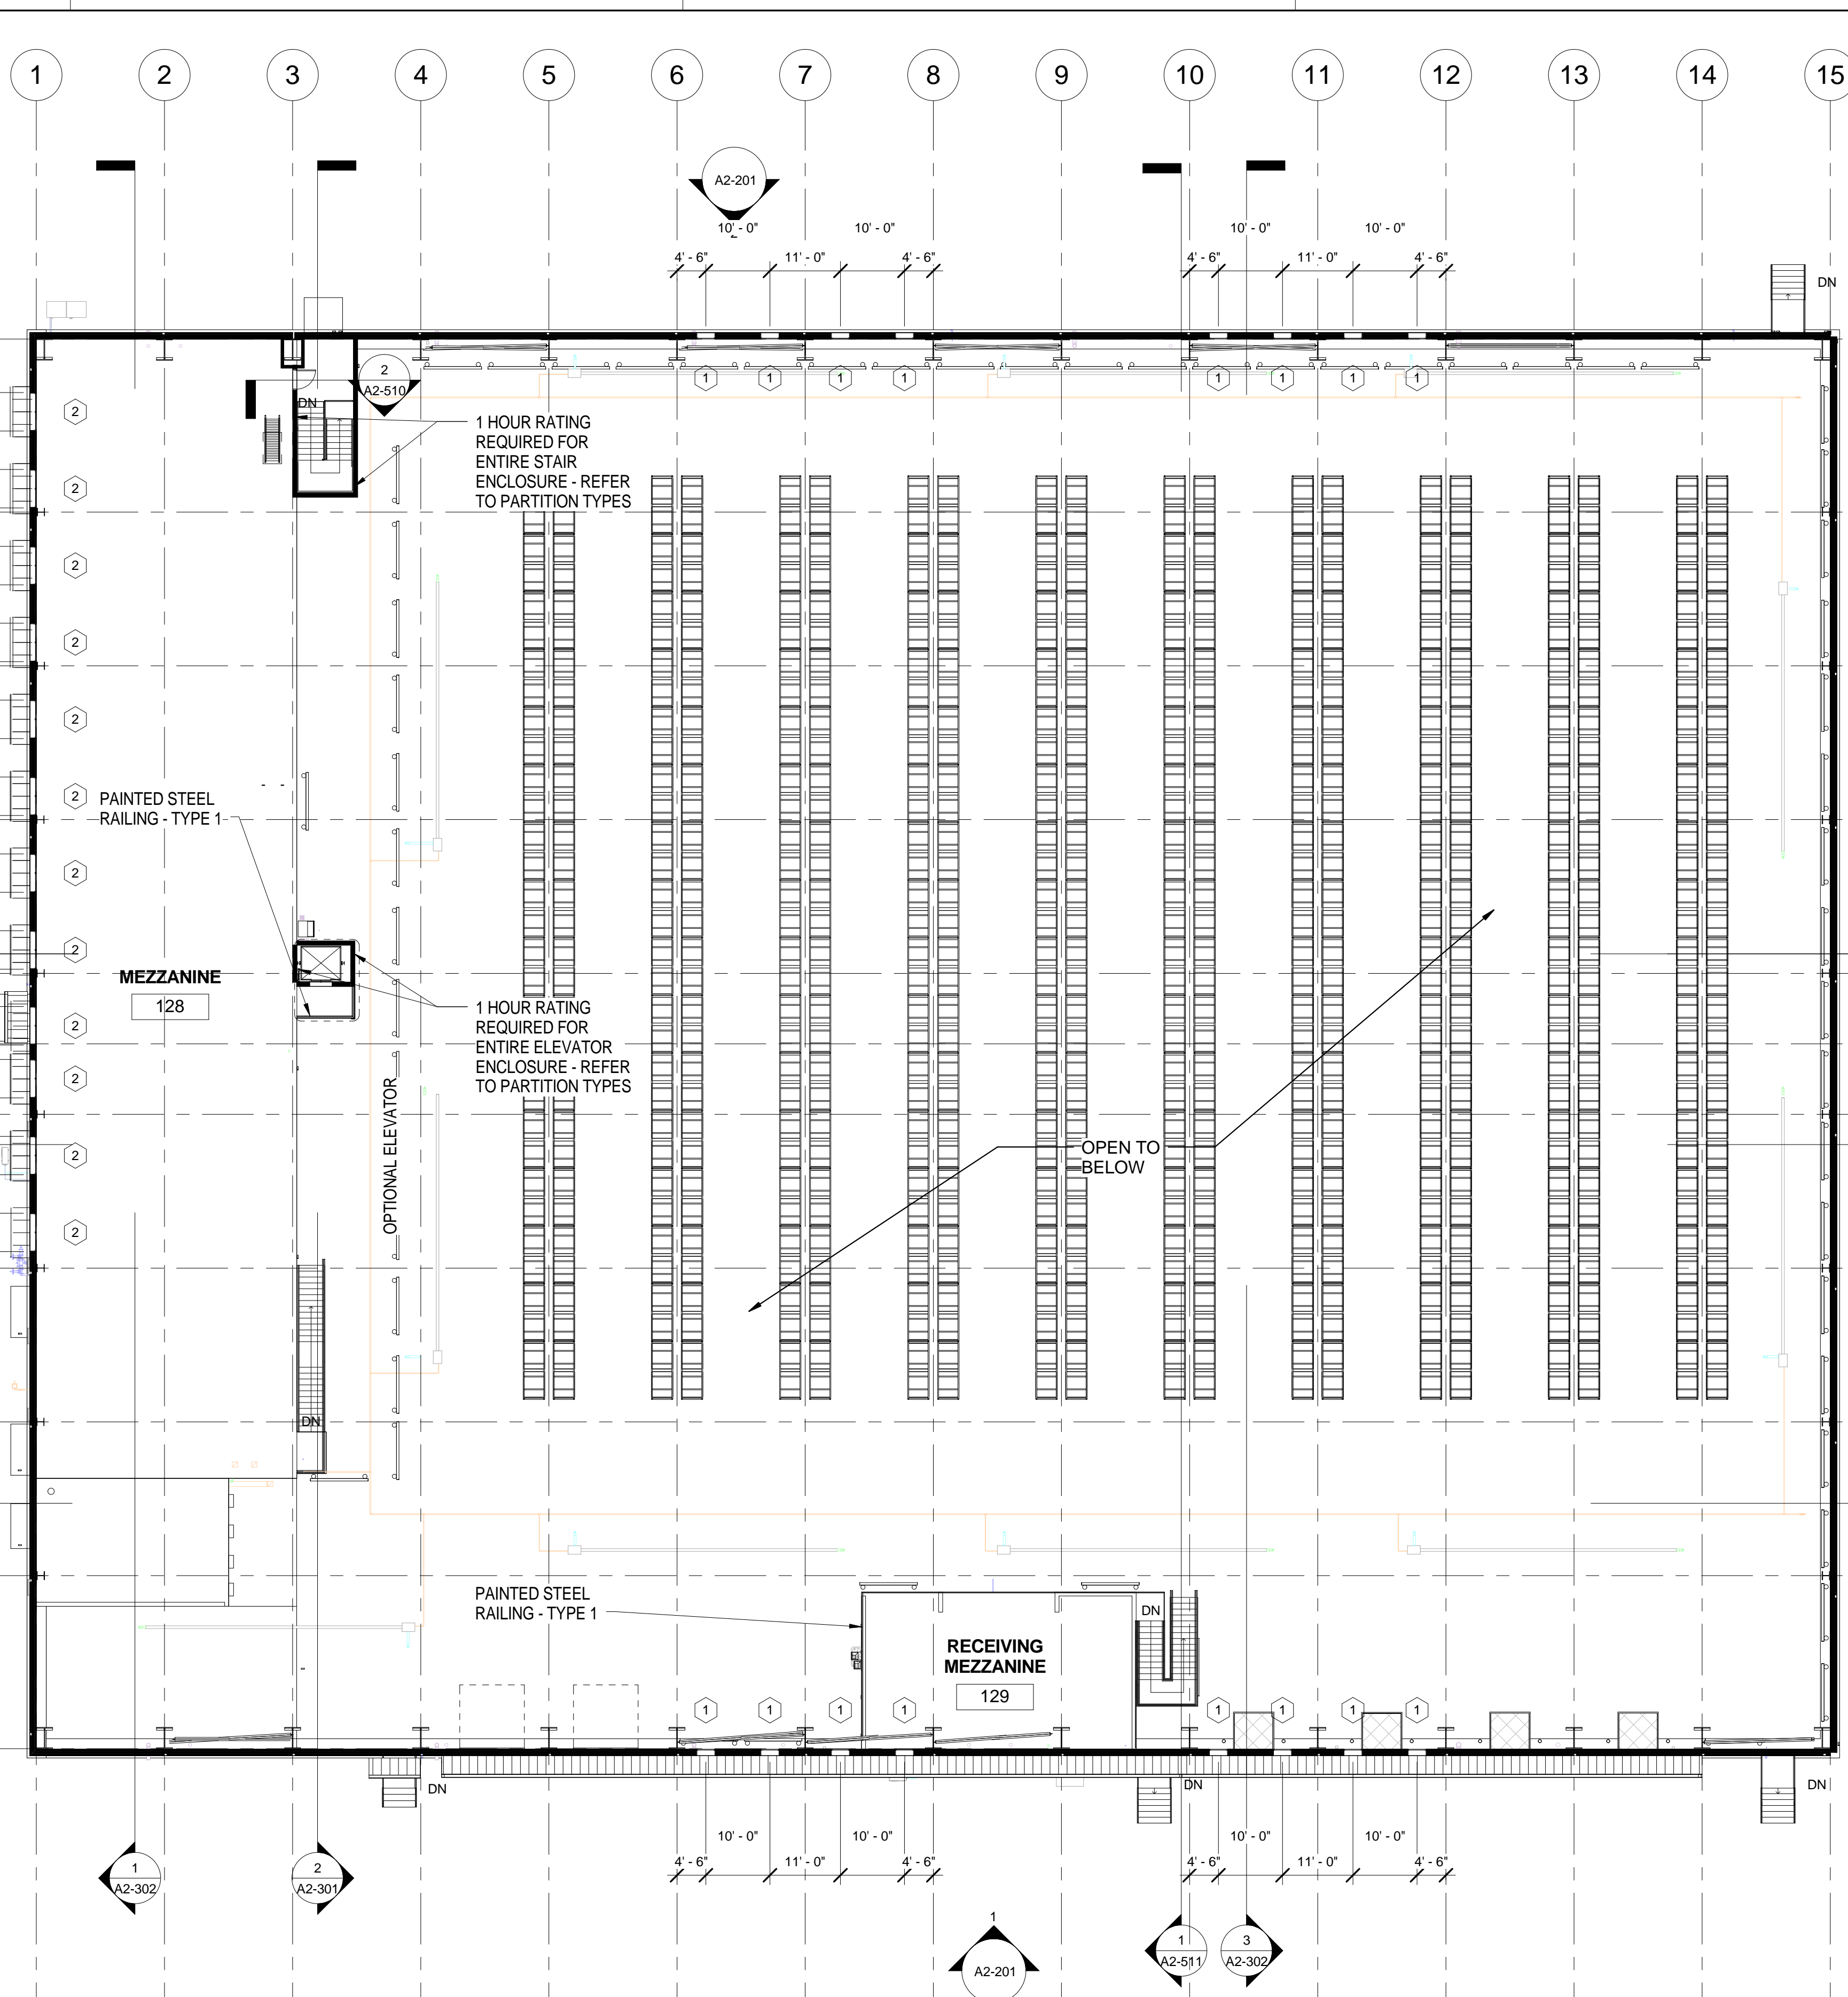
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1
A2-102
MEZZANINE PLAN
1/16" = 1'-0"

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DESIGN BY: US ARMY CORPS OF ENGINEERS	DATE: 2/13/2013
DRAWN BY: K. Pope	DESIGNED BY: K. Pope
PERMIT BY: K. Pope	PLOT DATE: 8/26/2014
PLOT SCALE: 1/16" = 1'-0"	FILE NUMBER: 1-4625 PM
SIZE: 22" x 34"	FILE NAME: A2-301

GENERAL PURPOSE WAREHOUSE
PROTOTYPE DESIGN
65,000 SQUARE FOOT VERSION

MEZZANINE PLAN - CONCRETE OPTION





SHEET IDENTIFICATION: A2-102	SHEET OF 0
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STANDARDS SUBMITTAL NOT FOR CONSTRUCTION

1 2 3 4 5

1 2 3 4 5 6 7 8 9 10 11 12 13 14 15

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1 ROOF PLAN
1/16" = 1'-0"

3 DOWNSPOUT
3" = 1'-0"

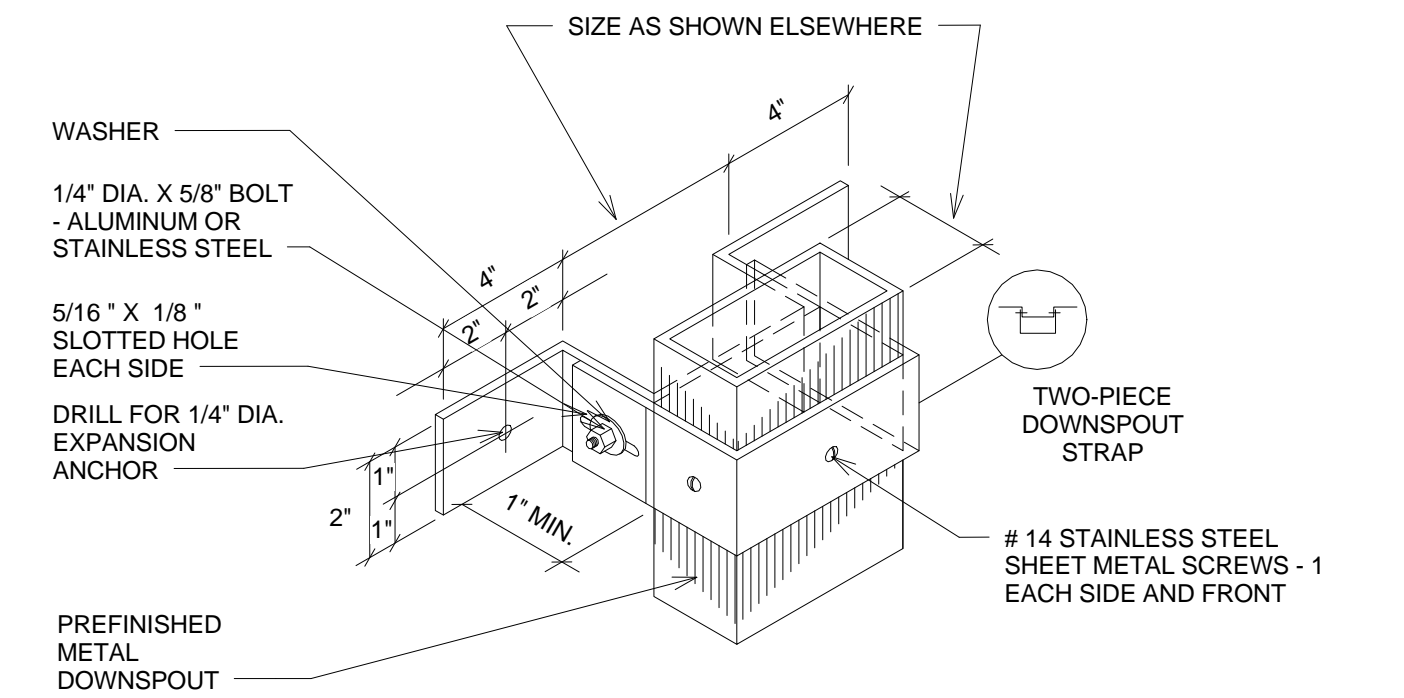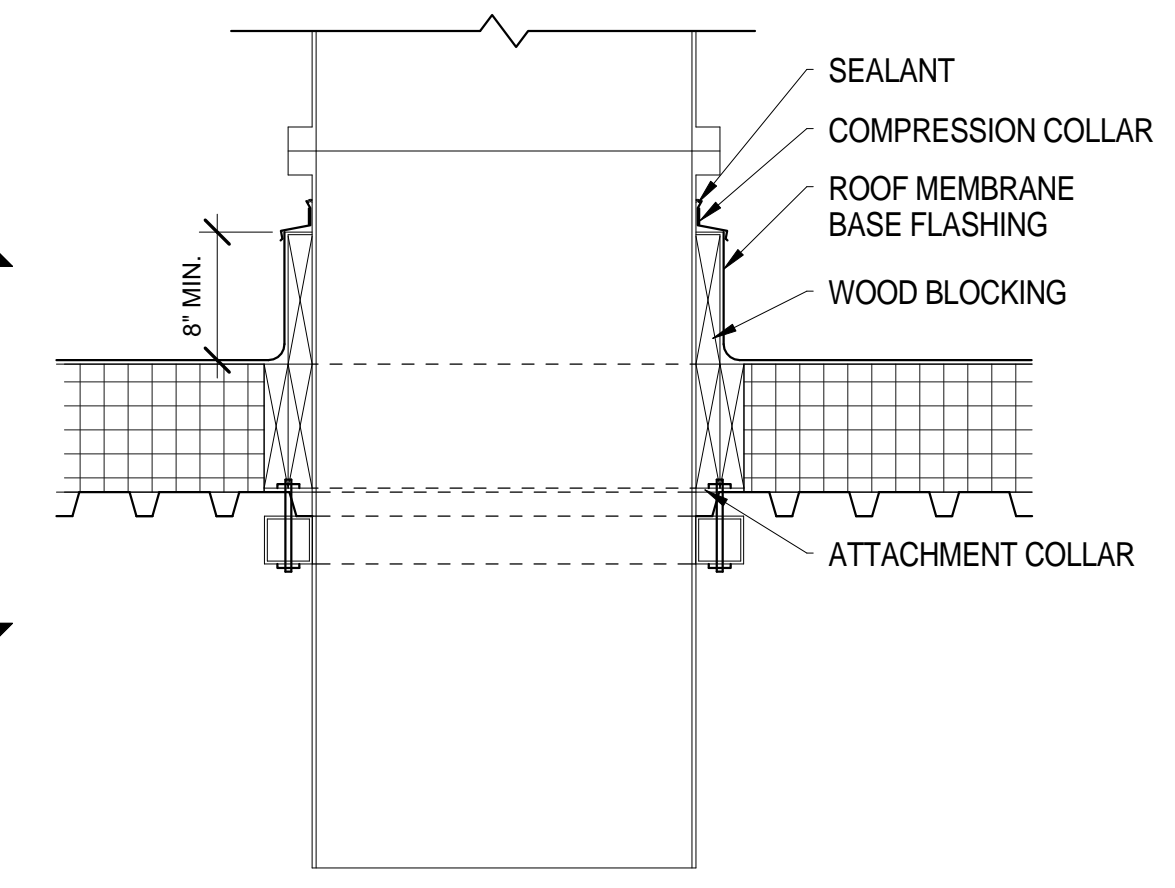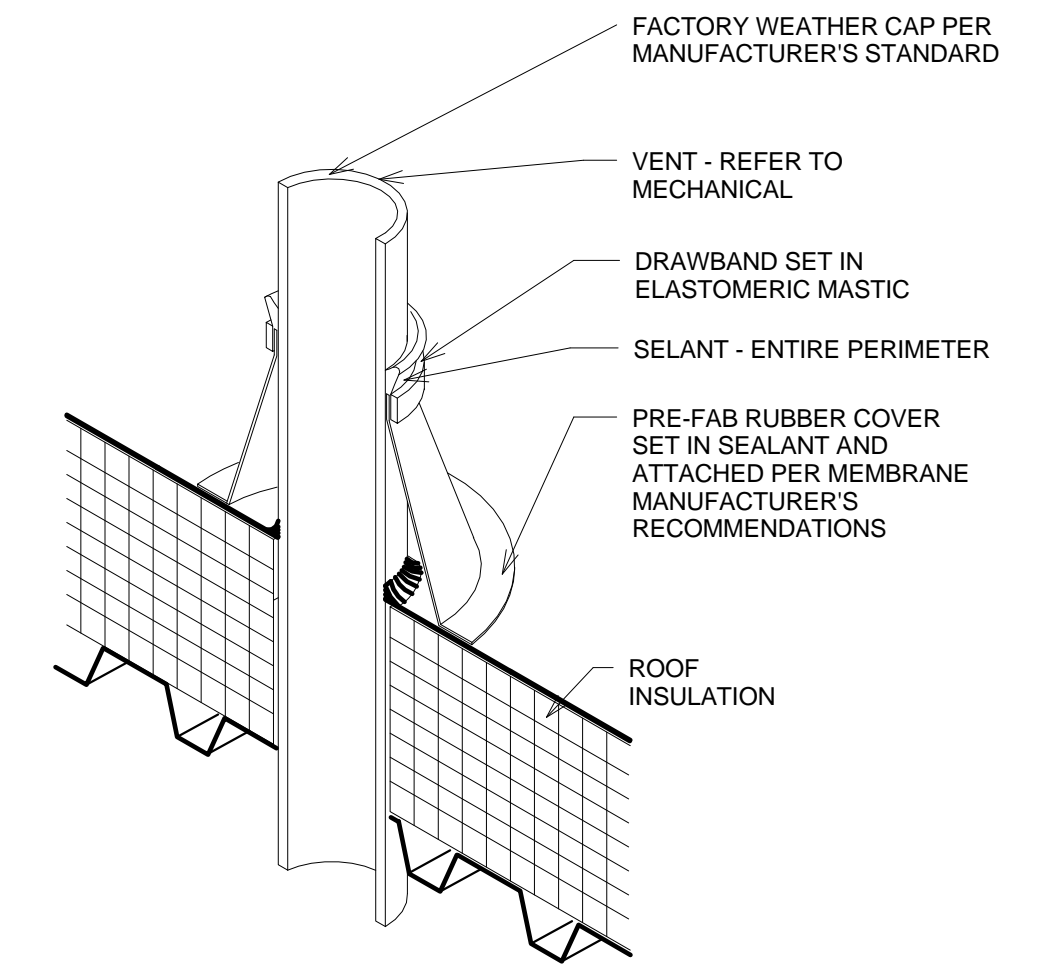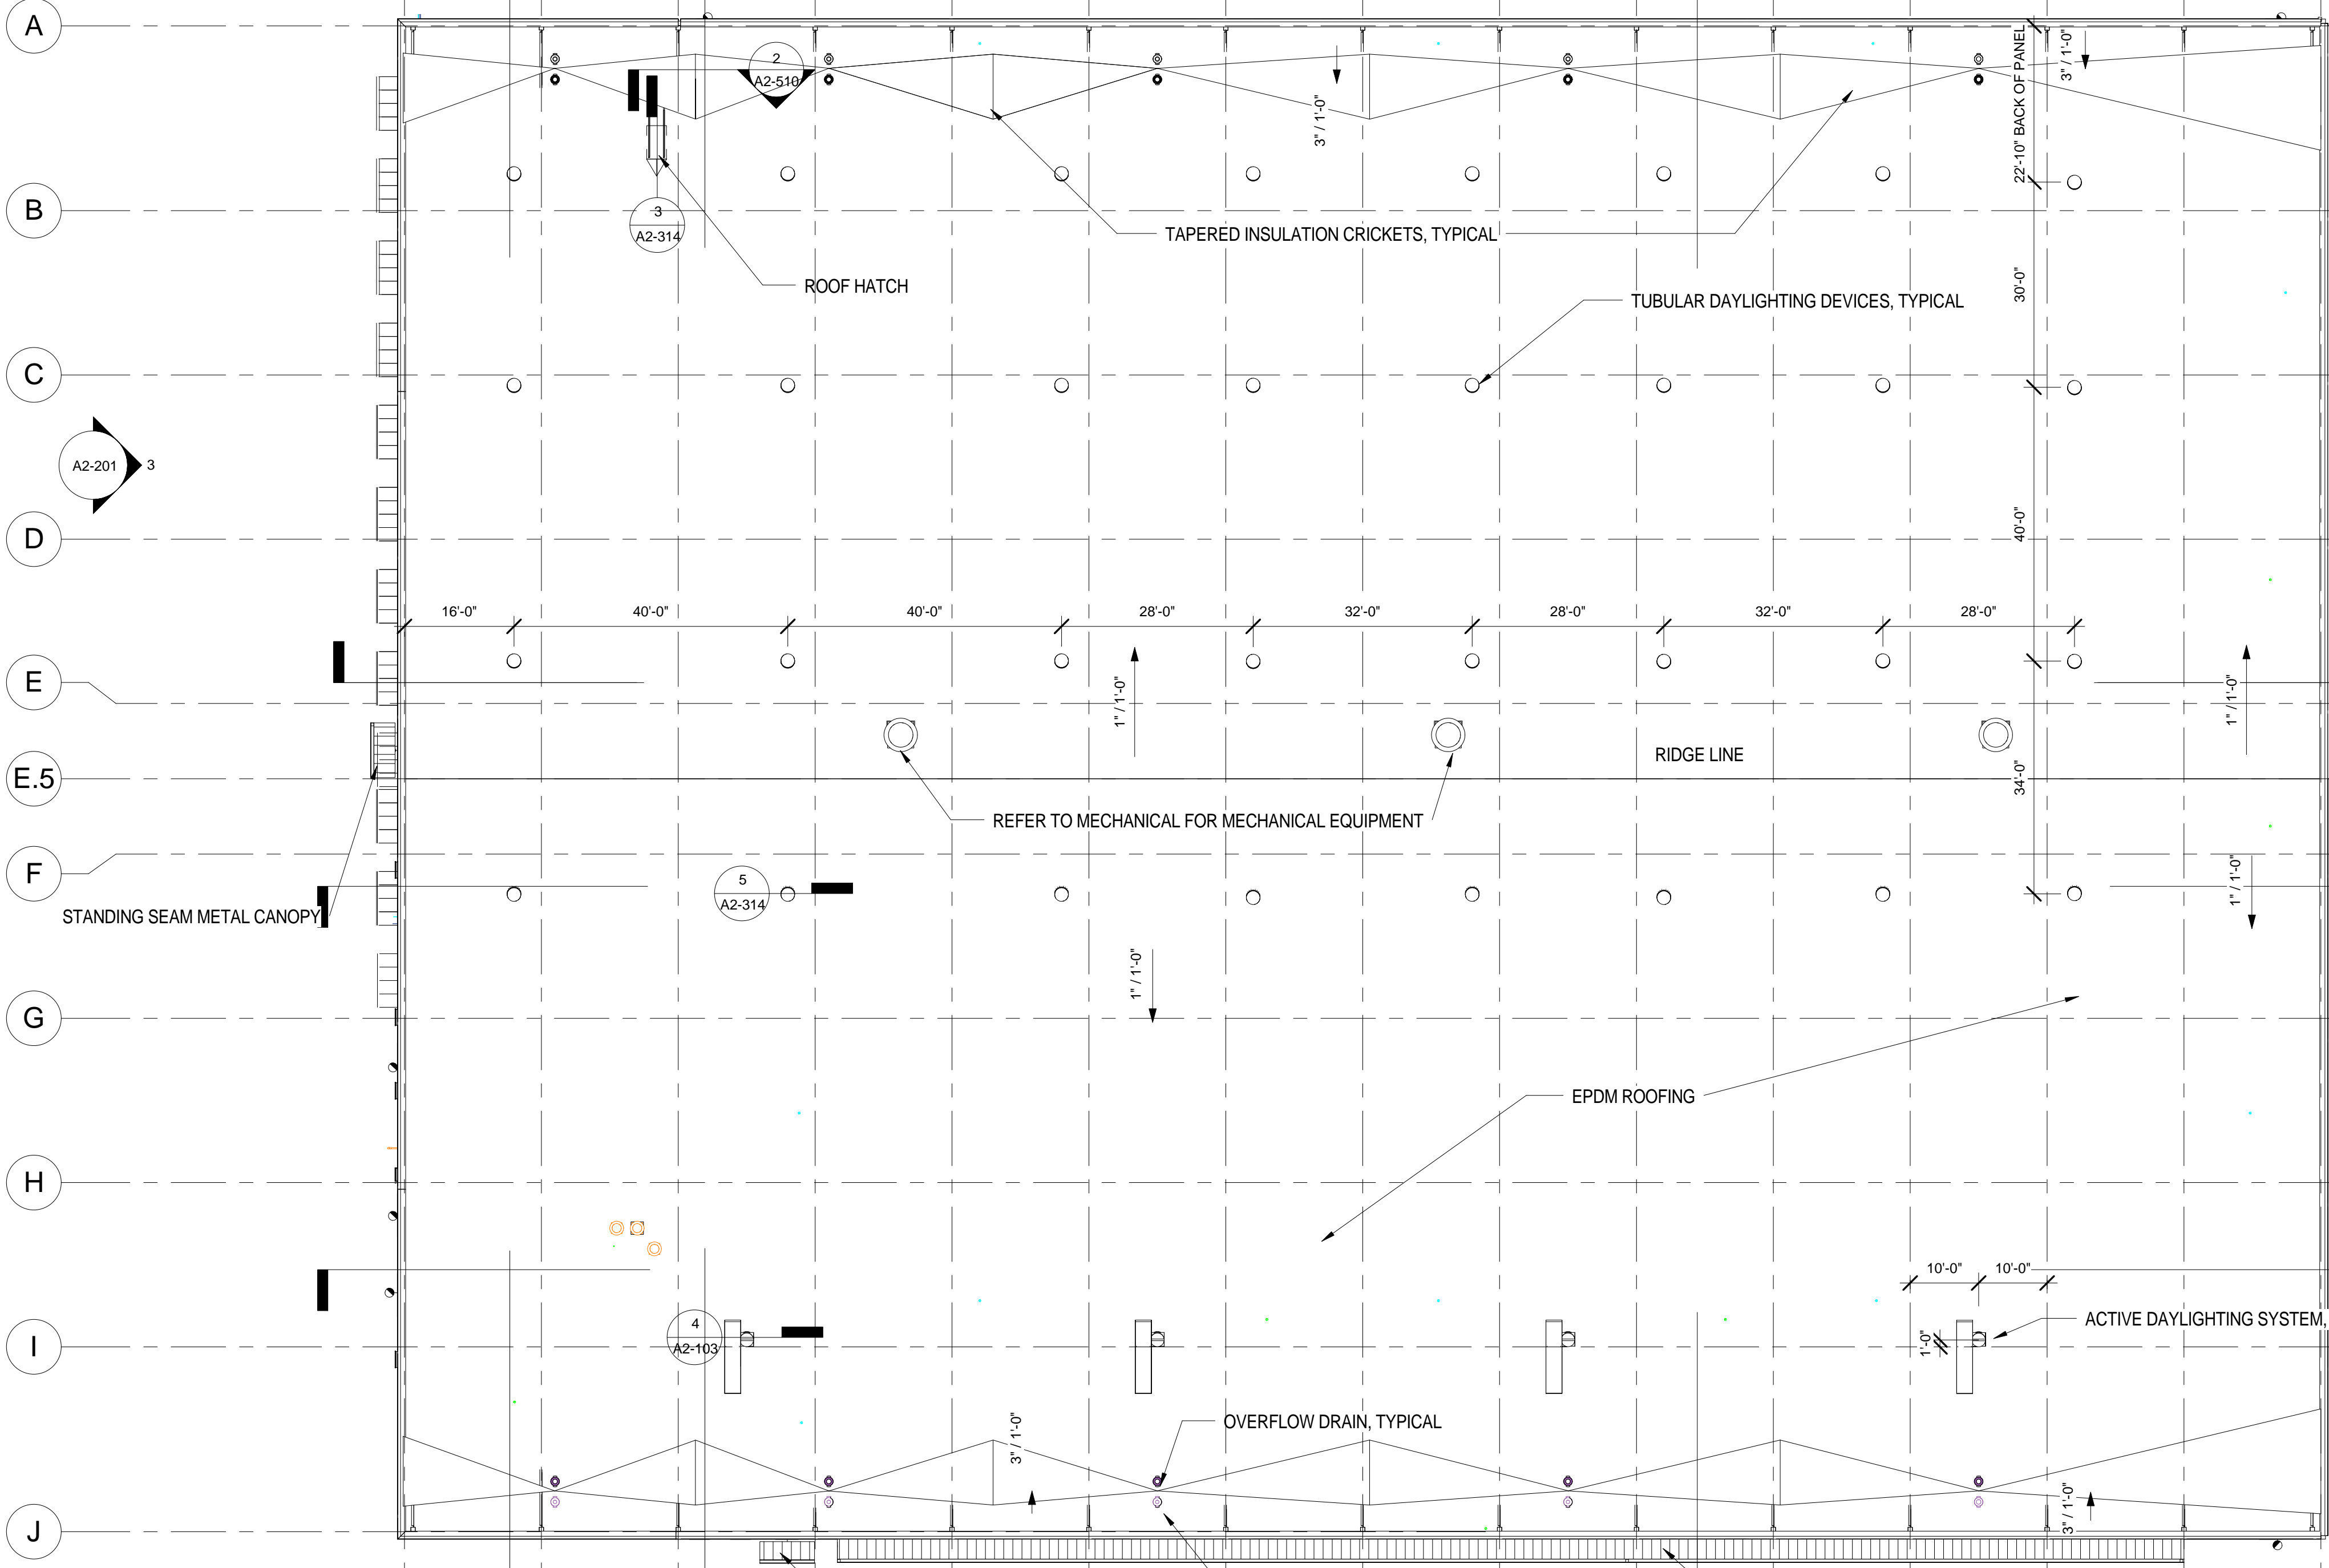

DATE	DESCRIPTION	APPROVED



DESIGN BY: K. Pope	DATE: 8/26/2014	SOLICITATION NO.:	CONTRACT NO.:
DESIGNED BY: K. Pope	PLotted DATE: 8/26/2014	FILE NUMBER:	FILE NAME:
SCALE: As indicated	SIZE: 22" x 34"		

US ARMY CORPS OF ENGINEERS
STANDARDS & SUSTAINABILITY


GENERAL PURPOSE WAREHOUSE
PROTOTYPE DESIGN
65,000 SQUARE FOOT VERSION
ROOF PLAN



SHEET IDENTIFICATION
A2-103
SHEET OF 0

STANDARDS SUBMITTAL NOT FOR CONSTRUCTION

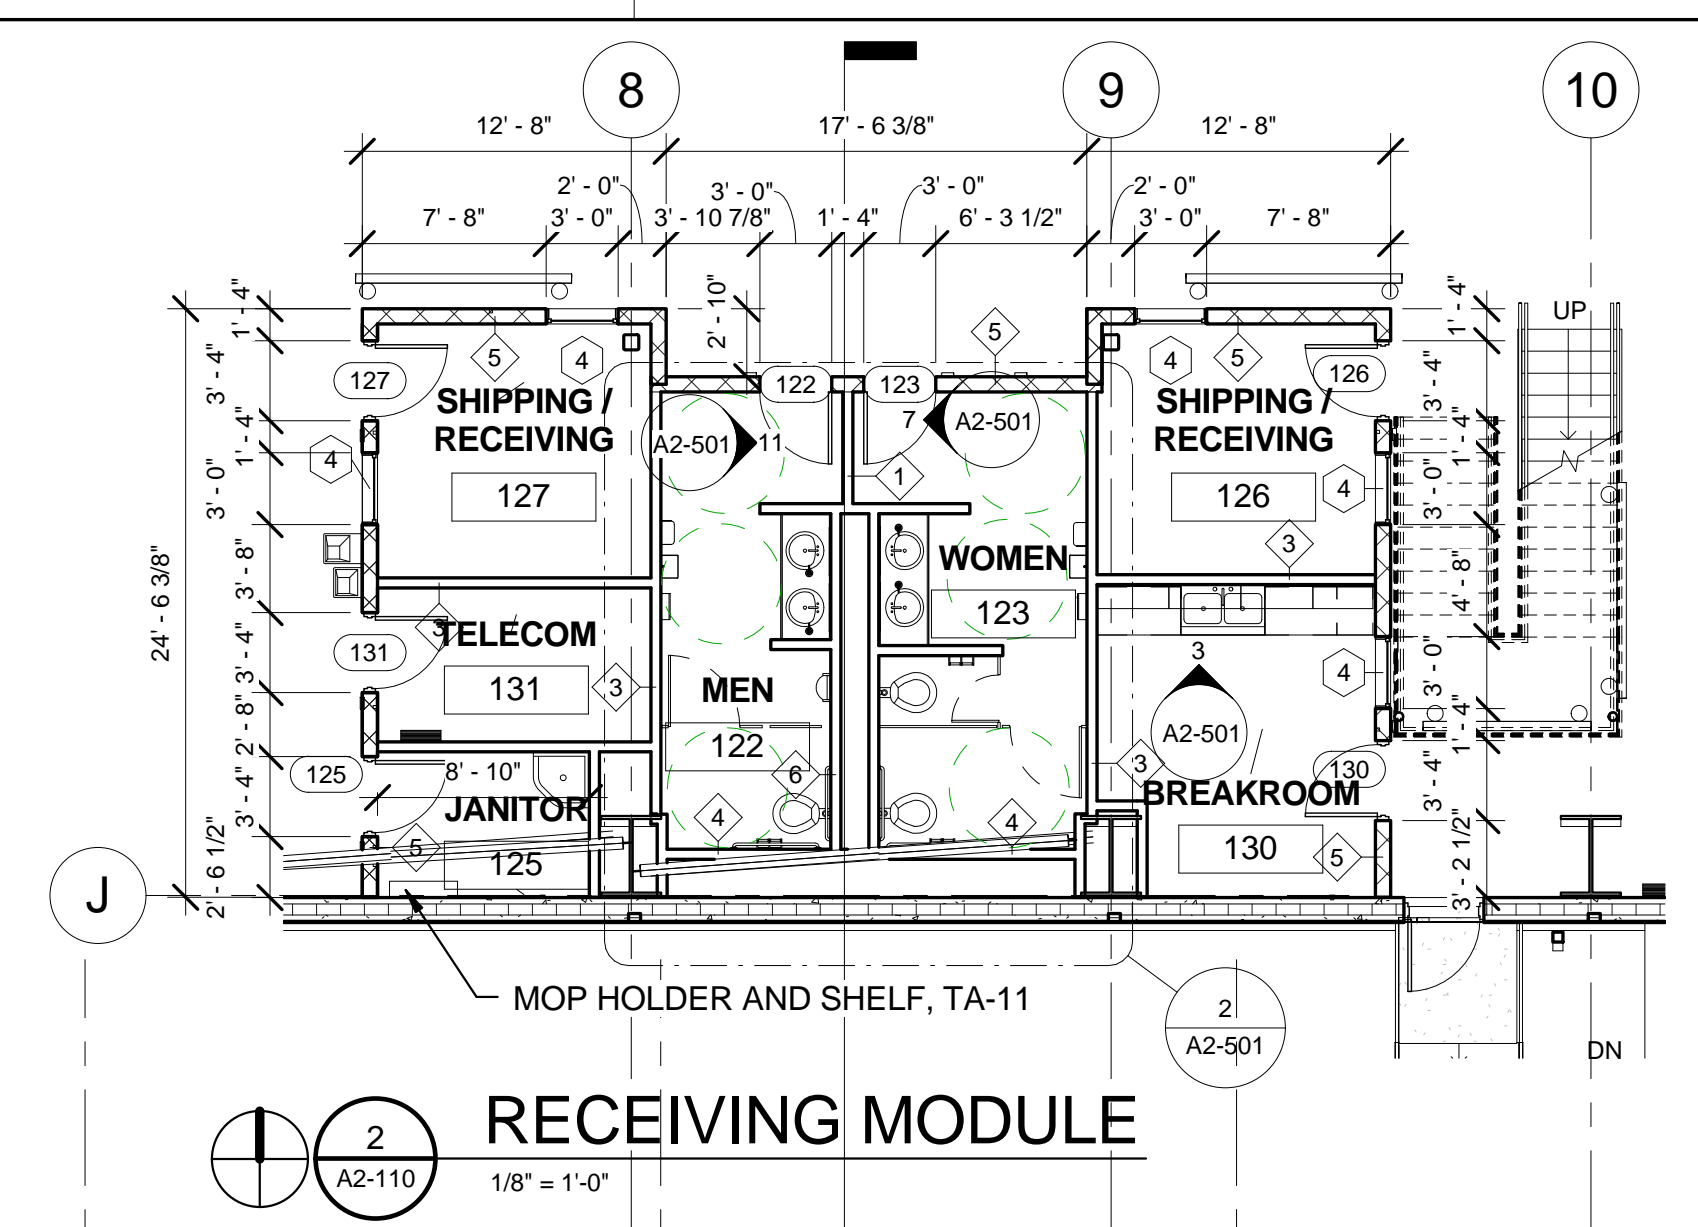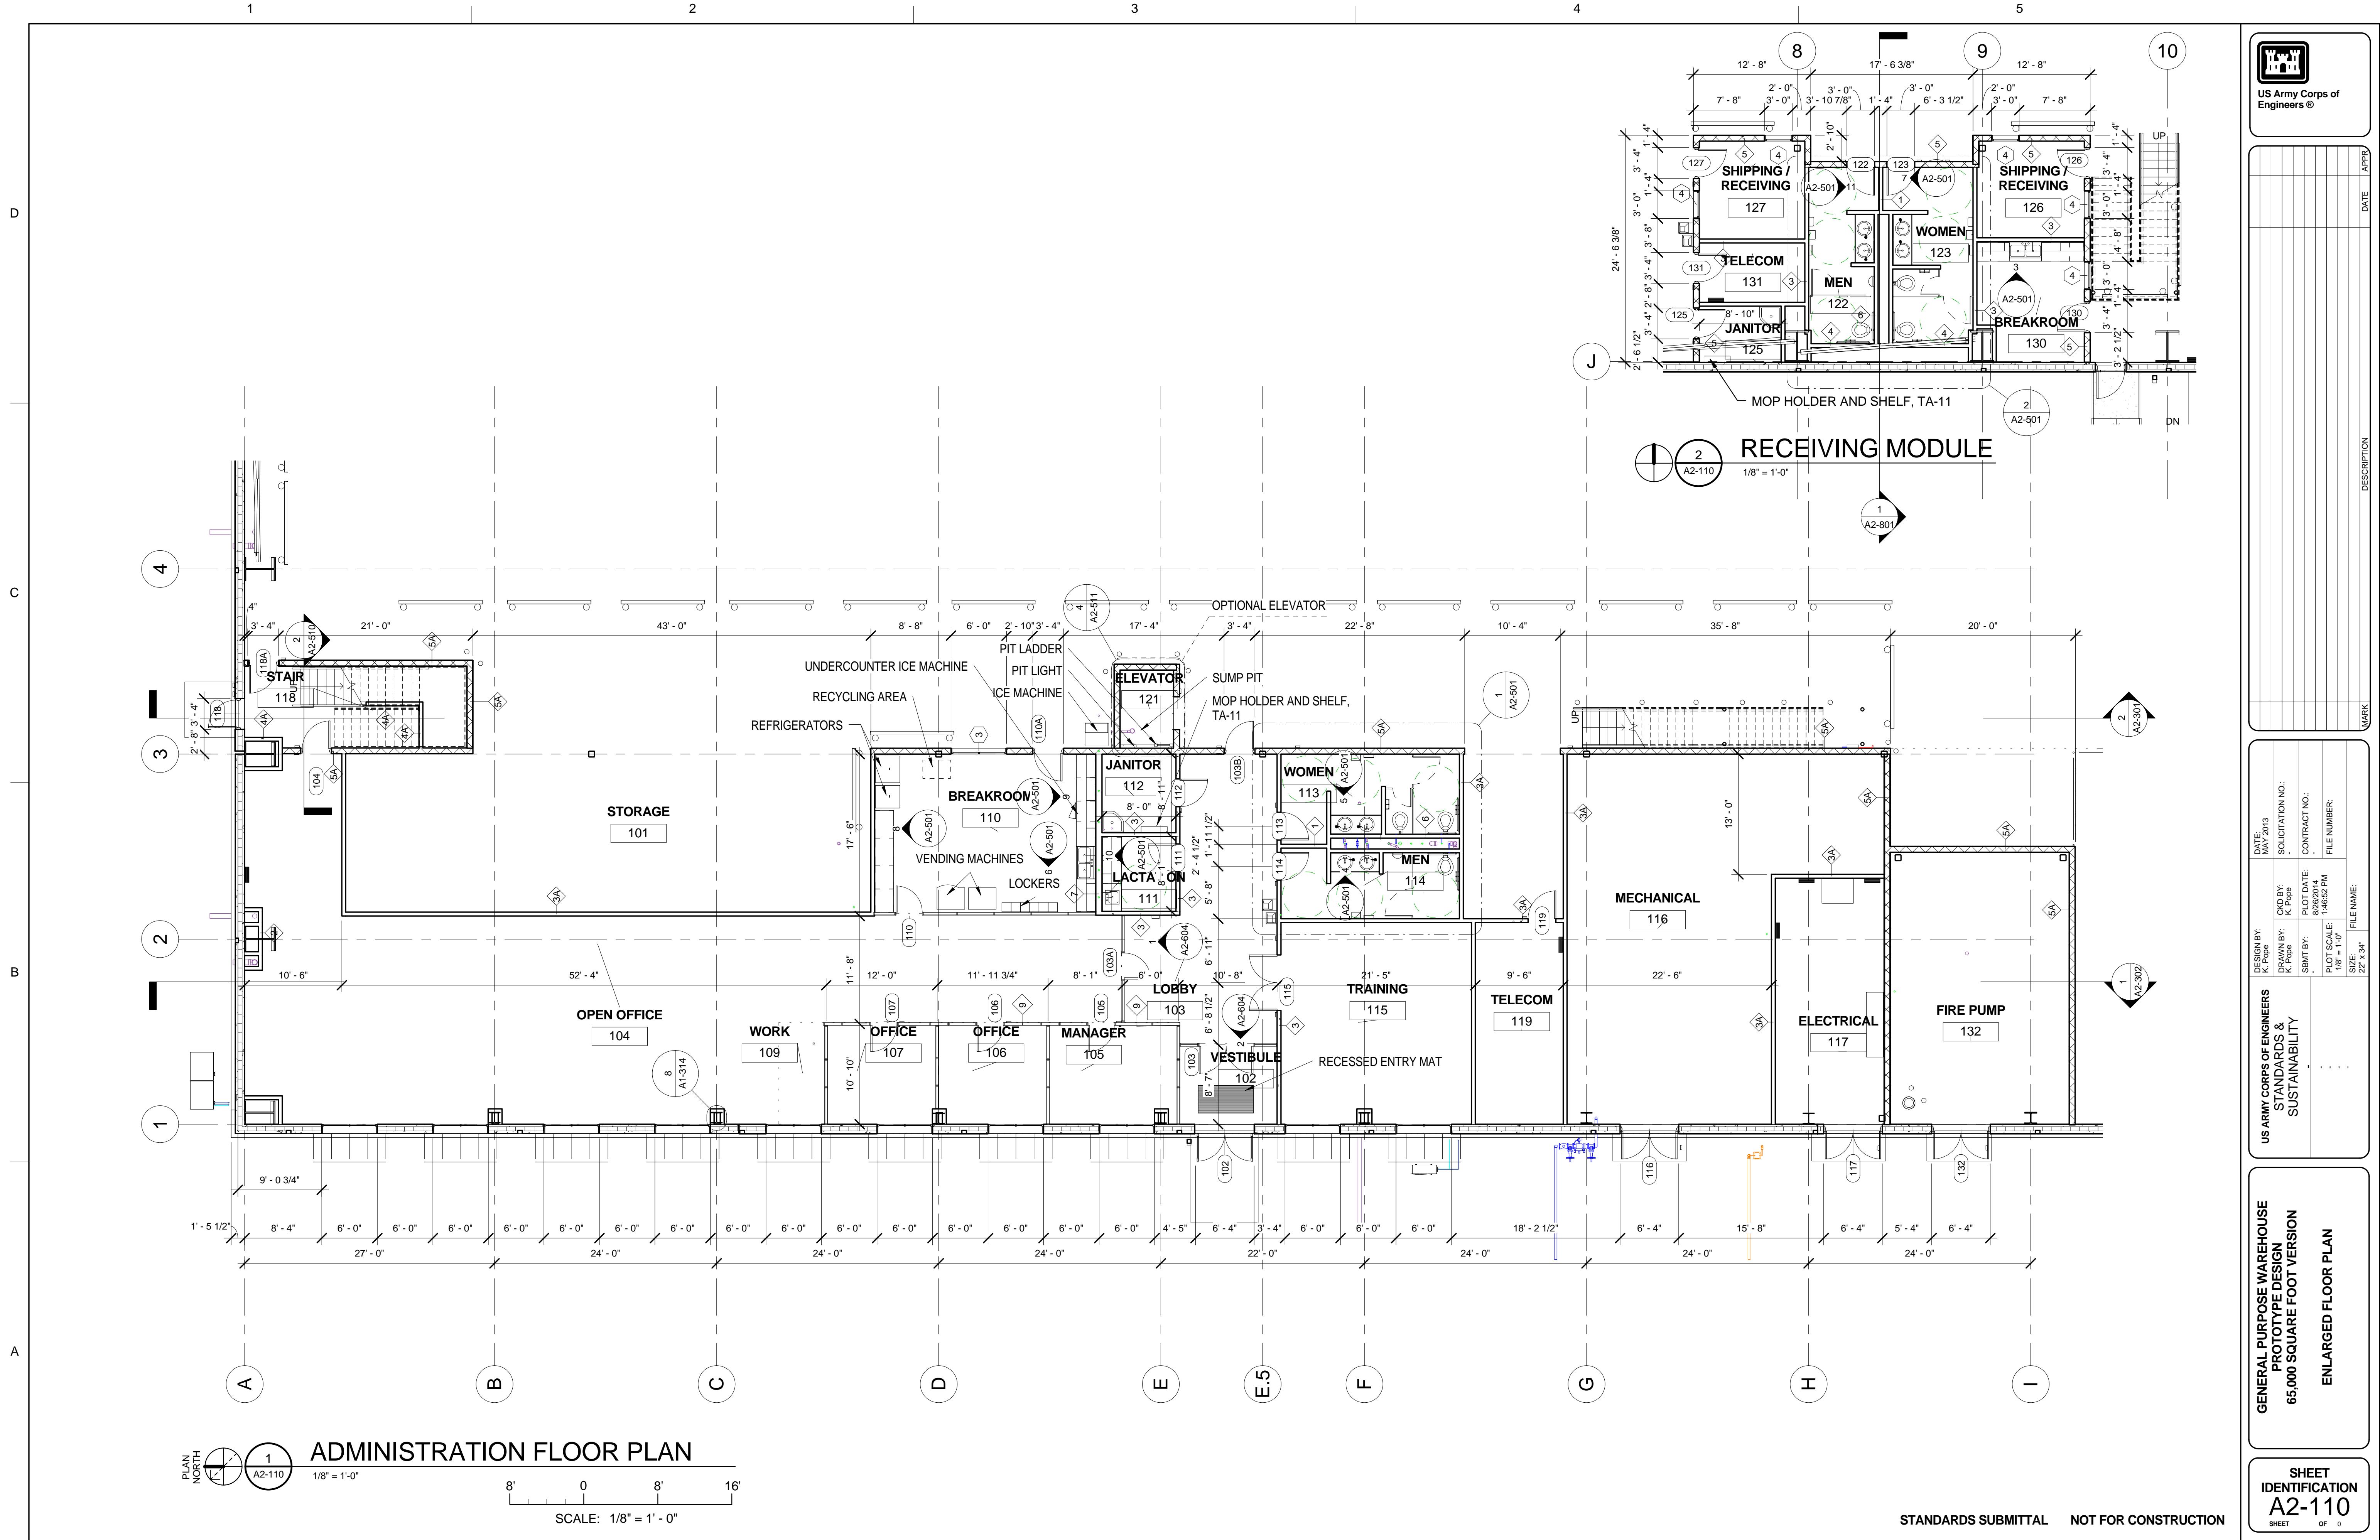


ADMINISTRATION FLOOR PLAN
 1/8" = 1'-0"
 SCALE: 1/8" = 1'-0"
 8' 0 8' 16'

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CHECKED BY: K. Pope	SOLICITATION NO.:
DRAWN BY: K. Pope	CONTRACT NO.:
PLOT DATE: 8/26/2014	FILE NUMBER:
PLOT SCALE: 1/8" = 1'-0"	FILE NAME:
PLOT SIZE: 22" x 34"	DATE:
US ARMY CORPS OF ENGINEERS STANDARDS & SUSTAINABILITY	DESCRIPTION:
GENERAL PURPOSE WAREHOUSE PROTOTYPE DESIGN 65,000 SQUARE FOOT VERSION ENLARGED FLOOR PLAN	MARK:
SHEET IDENTIFICATION A2-110 SHEET OF 0	DATE:

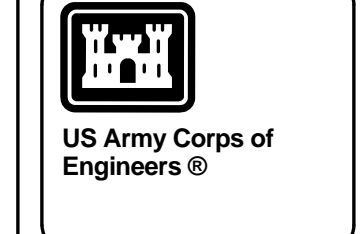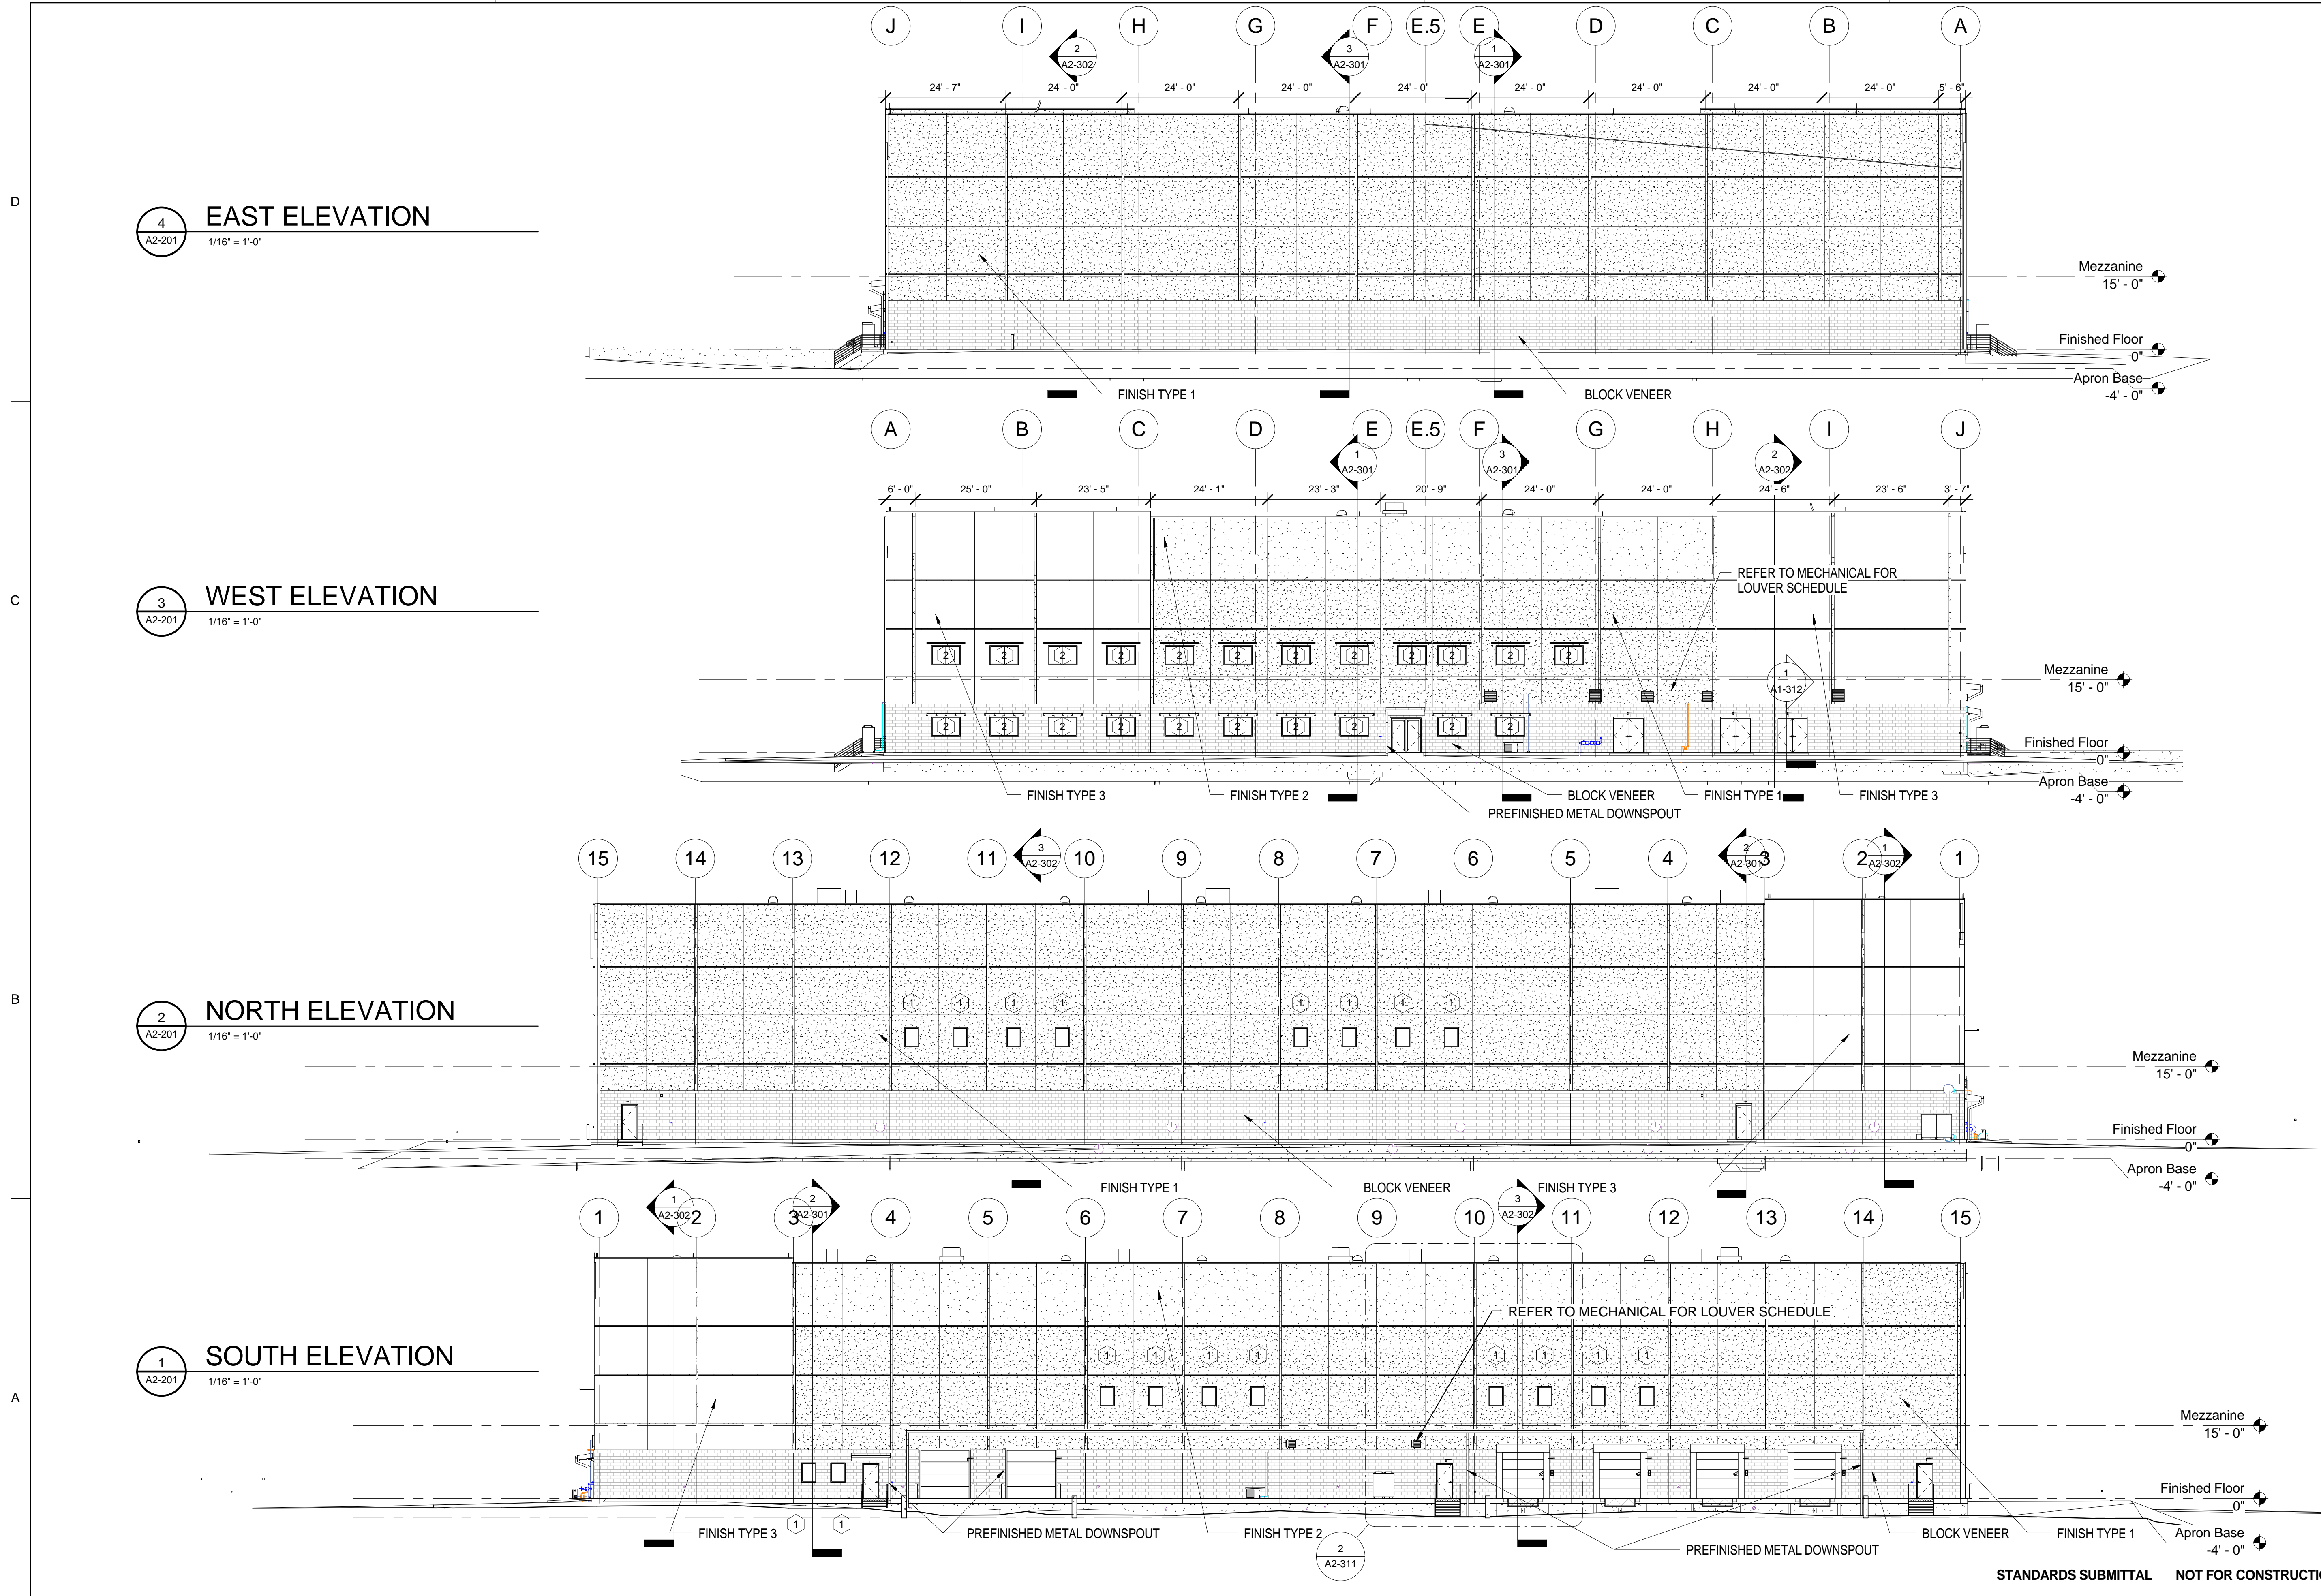

DATE	DESCRIPTION	APPROVED

DESIGN BY: K. Pope	CHECK BY: K. Pope	DATE: 8/26/2014	PROJECT NO.: A2-201
DESIGNED BY: K. Pope	DESIGNED BY: K. Pope	PLOT DATE: 8/26/2014	CONTRACT NO.:
US ARMY CORPS OF ENGINEERS STANDARDS & SUSTAINABILITY	FILE NAME:	FILE NUMBER:	FILE NUMBER:

GENERAL PURPOSE WAREHOUSE
PROTOTYPE DESIGN
65,000 SQUARE FOOT VERSION
EXTERIOR ELEVATIONS - CONCRETE
OPTION

SHEET IDENTIFICATION
A2-201
 SHEET OF 0

STANDARDS SUBMITTAL NOT FOR CONSTRUCTION

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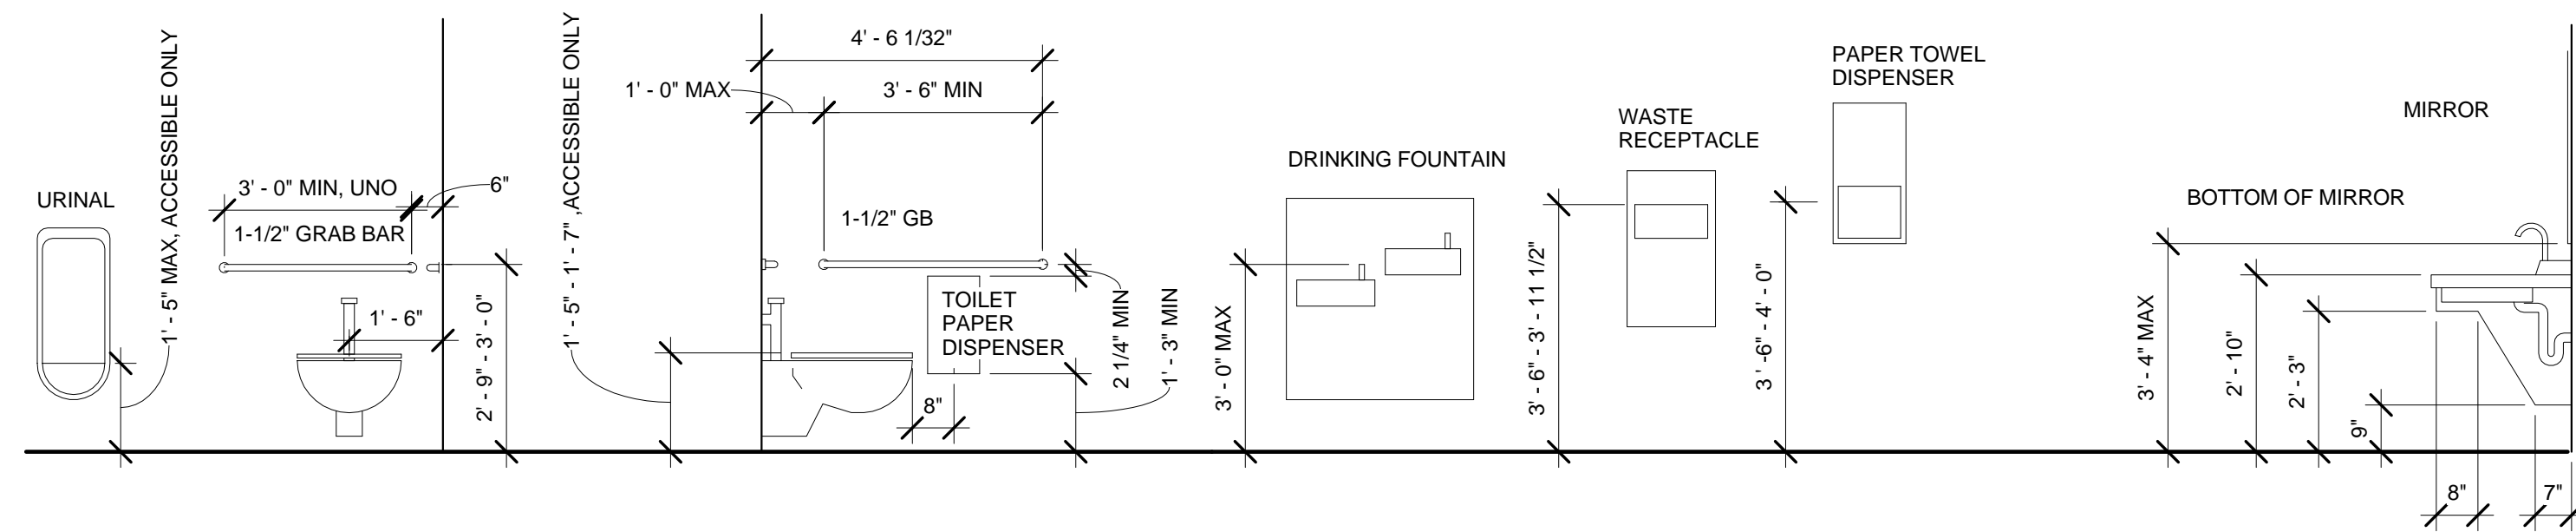
USACE_FINISH SCHEDULE

ROOM NO	ROOM NAME	WALL FINISH				BASE FINISH				FLOOR FINISH	CEILING		NOTES & REMARKS (SEE NOTES)	Area
		NORTH	EAST	SOUTH	WEST	NORTH	EAST	SOUTH	WEST		MAT.	HEIGHT		
101	STORAGE	Paint 01	Paint 01	Paint 01	Paint 01	-	-	-	-	Sealed Concrete	Painted Structure	0"		52575 SF
102	VESTIBULE	Wall System	Wall System	Paint 01	Paint 01	Rubber Base	Rubber Base	Rubber Base	Rubber Base	Sealed Concrete	Acoustic Tile	9' - 0"		92 SF
103	LOBBY	Paint 01	Paint 01	Paint 01	Wall System	Rubber Base	Rubber Base	Rubber Base	Rubber Base	Carpet Tile	Acoustic Tile	9' - 0"		401 SF
104	OPEN OFFICE	Paint 01	Paint 01	Wall System	Paint 01	Rubber Base	Rubber Base	Rubber Base	Rubber Base	Carpet Tile	Acoustic Tile	9' - 0"		1880 SF
105	MANAGER	Wall System	Wall System	Wall System	Paint 01	Rubber Base	Rubber Base	Rubber Base	Rubber Base	Carpet Tile	Acoustic Tile	9' - 0"		154 SF
106	OFFICE	Wall System	Wall System	Wall System	Paint 01	Rubber Base	Rubber Base	Rubber Base	Rubber Base	Carpet Tile	Acoustic Tile	9' - 0"		131 SF
107	OFFICE	Wall System	Wall System	Wall System	Paint 01	Rubber Base	Rubber Base	Rubber Base	Rubber Base	Carpet Tile	Acoustic Tile	9' - 0"		132 SF
109	WORK	Wall System	Wall System	Wall System	Wall System	Rubber Base	Rubber Base	Rubber Base	Rubber Base	Carpet Tile	Acoustic Tile	9' - 0"		56 SF
110	BREAKROOM	Wall System	Paint 01	Wall System	Wall System	Rubber Base	Rubber Base	Rubber Base	Rubber Base	Sealed Concrete	Acoustic Tile	9' - 0"		411 SF
111	LACTATION	Paint 01	Paint 01	Paint 01	Paint 01	Rubber Base	Rubber Base	Rubber Base	Rubber Base	Sealed Concrete	Acoustic Tile	9' - 0"		65 SF
112	JANITOR	FRP / Paint 01	FRP / Paint 01	FRP / Paint 01	FRP / Paint 01	Ceramic Tile	Ceramic Tile	Ceramic Tile	Ceramic Tile	Sealed Concrete	Gyp. Board - Painted	9' - 0"		68 SF
113	WOMEN	Ceramic Tile	Ceramic Tile	Ceramic Tile	Ceramic Tile	Ceramic Tile	Ceramic Tile	Ceramic Tile	Ceramic Tile	Ceramic Tile	Gyp. Board - Painted	9' - 0"		168 SF
114	MEN	Ceramic Tile	Ceramic Tile	Ceramic Tile	Ceramic Tile	Ceramic Tile	Ceramic Tile	Ceramic Tile	Ceramic Tile	Ceramic Tile	Gyp. Board - Painted	9' - 0"		138 SF
115	TRAINING	Paint 01	Paint 01	Paint 01	Paint 01	Rubber Base	Rubber Base	Rubber Base	Rubber Base	Carpet Tile	Acoustic Tile	9' - 0"		446 SF
116	MECHANICAL	Paint 01	Paint 01	Paint 01	Paint 01	-	-	-	-	Sealed Concrete	Painted Structure	0"		1042 SF
117	ELECTRICAL	Paint 01	Paint 01	Paint 01	Paint 01	-	-	-	-	Sealed Concrete	Painted Structure	0"		314 SF
118	STAIR	Paint 01	Paint 01	Paint 01	Paint 01	-	-	-	-	Sealed Concrete	Painted Structure	0"		201 SF
119	TELECOM	Paint 01	Paint 01	Paint 01	Paint 01	Rubber Base	Rubber Base	Rubber Base	Rubber Base	Sealed Concrete	Gyp. Board - Painted	10' - 0"		207 SF
120	RECHARGE	Paint 01	-	Paint 01	Paint 01	-	-	-	-	Sealed Concrete	Painted Structure	0"		212 SF
121	ELEVATOR	Laminate	Laminate	Laminate	Laminate	-	-	-	-	Manuf. Standard	Stainless Steel	0"		49 SF
122	MEN	Ceramic Tile	Ceramic Tile	Ceramic Tile	Ceramic Tile	Ceramic Tile	Ceramic Tile	Ceramic Tile	Ceramic Tile	Ceramic Tile	Gyp. Board - Painted	9' - 0"		135 SF
123	WOMEN	Ceramic Tile	Ceramic Tile	Ceramic Tile	Ceramic Tile	Ceramic Tile	Ceramic Tile	Ceramic Tile	Ceramic Tile	Ceramic Tile	Gyp. Board - Painted	9' - 0"		166 SF
125	JANITOR	FRP / Paint 01	Ceramic Tile	FRP / Paint 01	FRP / Paint 01	Ceramic Tile	Ceramic Tile	Ceramic Tile	Ceramic Tile	Sealed Concrete	Gyp. Board - Painted	9' - 0"		54 SF
126	SHIPPING / RECEIVING	Paint 01	Paint 01	Paint 01	Paint 01	Rubber Base	Rubber Base	Rubber Base	Rubber Base	Carpet Tile	Acoustic Tile	9' - 0"		121 SF
127	SHIPPING / RECEIVING	Paint 01	Paint 01	Paint 01	Paint 01	Rubber Base	Rubber Base	Rubber Base	Rubber Base	Carpet Tile	Acoustic Tile	9' - 0"		121 SF
128	MEZZANINE	-	-	-	Paint 01	-	-	-	-	Sealed Concrete	Painted Structure	0"		7204 SF
129	RECEIVING MEZZANINE	-	-	Paint 01	-	-	-	-	-	Sealed Concrete	Painted Structure	0"		1052 SF
130	BREAKROOM	Paint 01	Paint 01	Paint 01	Wall System	Rubber Base	Rubber Base	Rubber Base	Rubber Base	Sealed Concrete	Acoustic Tile	9' - 0"		143 SF
131	TELECOM	Paint 01	Paint 01	Paint 01	Paint 01	-	-	-	-	Sealed Concrete	Gyp. Board - Painted	10' - 0"		73 SF
132	FIRE PUMP	Paint 01	Paint 01	Paint 01	Paint 01	-	-	-	Ceramic Tile	Sealed Concrete	Painted Structure	0"		569 SF
133	HOLDING	Paint 01	-	Paint 01	Paint 01	-	-	-	Ceramic Tile	Sealed Concrete	Painted Structure	0"		905 SF



DATE	DESCRIPTION	DATE	APPRO

DESIGN BY: K. Papp	CHECK BY: K. Papp	DATE: 03/20/2013
DESIGNED BY: K. Papp	PLotted BY: 8/26/2014	PROJECT NO.: 82602014
CONTRACT NO.:	FILE NUMBER:	FILE NAME:
DATE: 03/20/2013	PLotted DATE: 8/26/2014	CONTRACT NO.:
SUBMIT BY: K. Papp	PLotted DATE: 1:47:28 PM	FILE NUMBER:
PLotted SCALE: 3/8" = 1'-0"	PLotted SIZE: 22" x 34"	FILE NAME:
US ARMY CORPS OF ENGINEERS		
STANDARDS & SUSTAINABILITY		



TYPICAL MOUNTING HEIGHTS
3/8" = 1'-0"

STANDARDS SUBMITTAL NOT FOR CONSTRUCTION

GENERAL PURPOSE WAREHOUSE
PROTOTYPE DESIGN
65,000 SQUARE FOOT VERSION
ROOM FINISH SCHEDULE

1

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Furniture System Door Schedule						
Door Number	Type	Width	Height	Type Comments	Finish Material	Fire Rating
103	7	6' - 0"	9' - 0"	Enclose Double Swing Door	Anodized	-
103A	6	3' - 0"	9' - 0"	Enclose Single Swing Door	Anodized	-
105	6	3' - 0"	9' - 0"	Enclose Single Swing Door	Anodized	-
106	6	3' - 0"	9' - 0"	Enclose Single Swing Door	Anodized	-
107	6	3' - 0"	9' - 0"	Enclose Single Swing Door	Anodized	-
110	6	3' - 0"	9' - 0"	Enclose Single Swing Door	Anodized	-

USACE DOOR SCHEDULE																		
Door Number	Type	DOOR SIZE			Type Comments	DOOR Material	Fire Rating	FRAME			DETAILS		Sill	Hardware	Comments			
		Width	Height	Thickness				Type	Material	Finish	Head	Jamb						
101	1	3' - 0"	7' - 0"	1 3/4"		Hollow Metal	-	02	Hollow Metal	PT-01	04/A2-312	05/A2-312	07/A-603	02				
101A	8	10' - 0"	10' - 0"	2"	Fast Opening	Insulated Panel	-	-	-	-	08/A2-312	09/A2-312	-	08				
101B	8	10' - 0"	10' - 0"	2"	Fast Opening	Insulated Panel	-	-	-	-	08/A2-312	09/A2-312	-	08				
101C	1	3' - 0"	7' - 0"	1 3/4"		Hollow Metal	-	02	Hollow Metal	PT-01	04/A2-312	02/A1-312	07/A-603	02				
101D	9	9' - 0"	10' - 0"	2"	Overhead	Insulated Panel	-	-	-	-	08/A2-312	09/A2-312	-	08				
101E	9	9' - 0"	10' - 0"	2"	Overhead	Insulated Panel	-	-	-	-	08/A2-312	09/A2-312	-	08				
101F	9	9' - 0"	10' - 0"	2"	Overhead	Insulated Panel	-	-	-	-	08/A2-312	09/A2-312	-	08				
101G	9	9' - 0"	10' - 0"	2"	Overhead	Insulated Panel	-	-	-	-	08/A2-312	09/A2-312	-	08				
101H	1	3' - 0"	7' - 0"	1 3/4"		Hollow Metal	-	02	Hollow Metal	PT-01	04/A2-312	05/A2-312	07/A-603	02				
101J	1	3' - 0"	7' - 0"	1 3/4"		Hollow Metal	-	02	Hollow Metal	PT-01	04/A2-312	05/A2-312	07/A-603	02				
102	3	6' - 0"	7' - 0"	1 3/4"		Aluminum	-	05	Aluminum	Anodized	07/A2-312	06/A2-312	07/A-603	09				
103B	2	3' - 0"	7' - 0"	1 3/4"		Hollow Metal	-	02	Hollow Metal	PT-01	05/A1-603	06/A1-603	-	01				
104	1R	3' - 0"	7' - 0"	1 3/4"		Hollow Metal	45 Min	01R	Hollow Metal	PT-01	05/A1-603	06/A1-603	-	04				
110A	2	3' - 0"	7' - 0"	1 3/4"		Hollow Metal	-	02	Hollow Metal	PT-01	05/A1-603	06/A1-603	-	01				
111	1	3' - 0"	7' - 0"	1 3/4"		Hollow Metal	-	01	Hollow Metal	PT-01	03/A1-603	04/A1-603	-	01				
112	1	3' - 0"	7' - 0"	1 3/4"		Hollow Metal	-	01	Hollow Metal	PT-01	03/A1-603	04/A1-603	-	03				
113	1	3' - 0"	7' - 0"	1 3/4"		Hollow Metal	-	01	Hollow Metal	PT-01	03/A1-603	04/A1-603	-	06				
114	1	3' - 0"	7' - 0"	1 3/4"		Hollow Metal	-	01	Hollow Metal	PT-01	03/A1-603	04/A1-603	-	06				
115	4	6' - 0"	7' - 0"	1 3/4"		Hollow Metal	-	03	Hollow Metal	PT-01	03/A1-603	04/A1-603	-	10				
116	4	6' - 0"	7' - 0"	1 3/4"		Hollow Metal	-	04	Hollow Metal	PT-01	04/A2-312	07/A1-603	-	05				
117	4	6' - 0"	7' - 0"	1 3/4"		Hollow Metal	-	04	Hollow Metal	PT-01	04/A2-312	07/A1-603	-	05				
118	2	3' - 0"	7' - 0"	1 3/4"		Hollow Metal	-	02	Hollow Metal	PT-01	04/A2-312	07/A1-603	07/A-603	02				
118A	1R	3' - 0"	7' - 0"	1 3/4"		Hollow Metal	45 Min	01R	Hollow Metal	PT-01	05/A1-603	06/A1-603	-	04				
119	1	3' - 0"	7' - 0"	1 3/4"		Hollow Metal	-	02	Hollow Metal	PT-01	05/A1-603	06/A1-603	-	03				
122	1	3' - 0"	7' - 0"	1 3/4"		Hollow Metal	-	02	Hollow Metal	PT-01	05/A1-603	06/A1-603	-	06				
123	1	3' - 0"	7' - 0"	1 3/4"		Hollow Metal	-	02	Hollow Metal	PT-01	05/A1-603	06/A1-603	-	06				
125	1	3' - 0"	7' - 0"	1 3/4"		Hollow Metal	-	02	Hollow Metal	PT-01	05/A1-603	06/A1-603	-	03				
126	1	3' - 0"	7' - 0"	1 3/4"		Hollow Metal	-	02	Hollow Metal	PT-01	05/A1-603	06/A1-603	-	01				
127	1	3' - 0"	7' - 0"	1 3/4"		Hollow Metal	-	02	Hollow Metal	PT-01	05/A1-603	06/A1-603	-	01				
130	1	3' - 0"	7' - 0"	1 3/4"		Hollow Metal	-	02	Hollow Metal	PT-01	05/A1-603	06/A1-603	-	01				
131	1	3' - 0"	7' - 0"	1 3/4"		Hollow Metal	-	02	Hollow Metal	PT-01	05/A1-603	06/A1-603	-	03				
132	4	6' - 0"	7' - 0"	1 3/4"		Hollow Metal	-	04	Hollow Metal	PT-01	04/A2-312	07/A1-603	-	05				
201	1R	3' - 0"	7' - 0"	1 3/4"		Hollow Metal	45 Min	01R	Hollow Metal	PT-01	03/A1-603	04/A1-603	-	04	Mezzanine Level			

US Army Corps of Engineers®


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D


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B


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OVERHEAD DOORS




FURNITURE SYSTEM DOORS

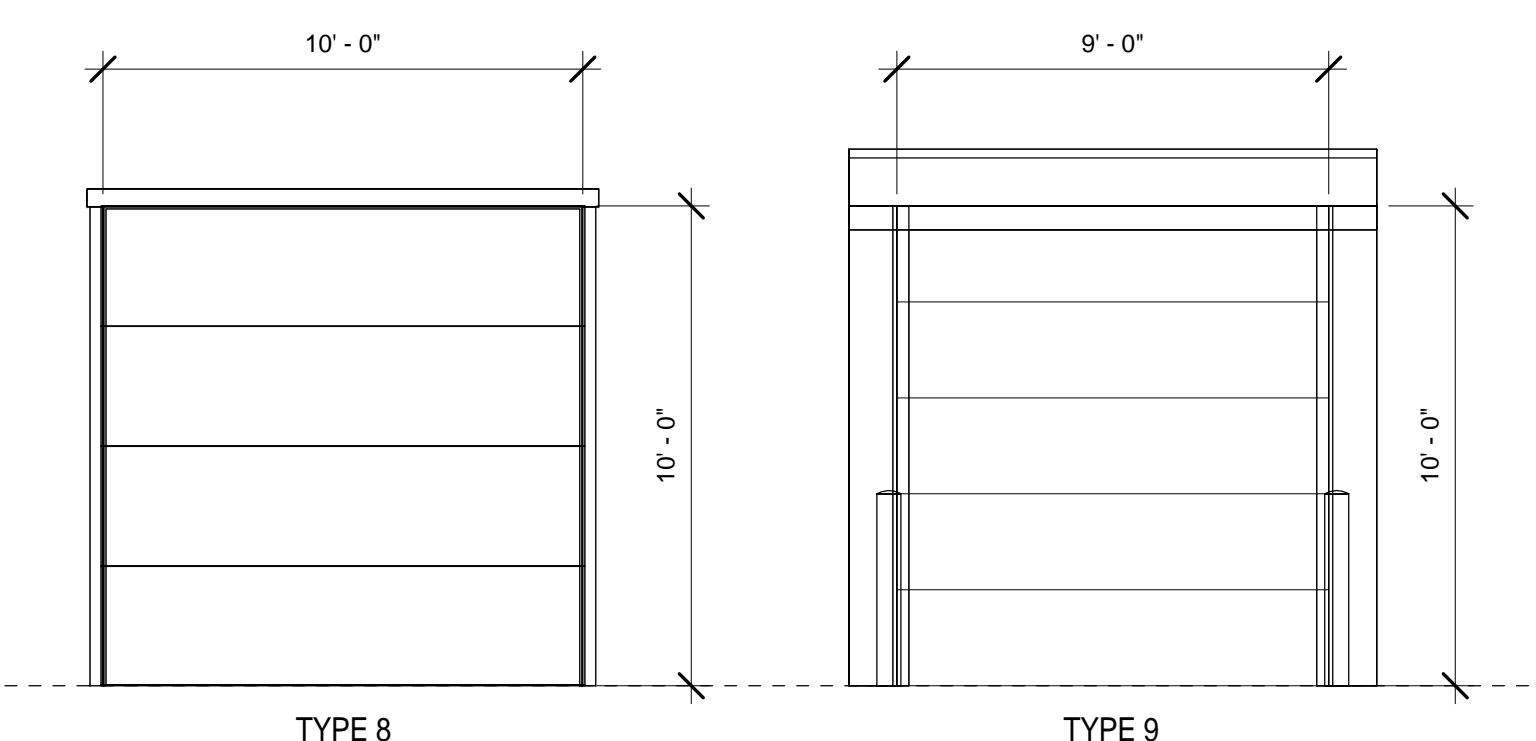

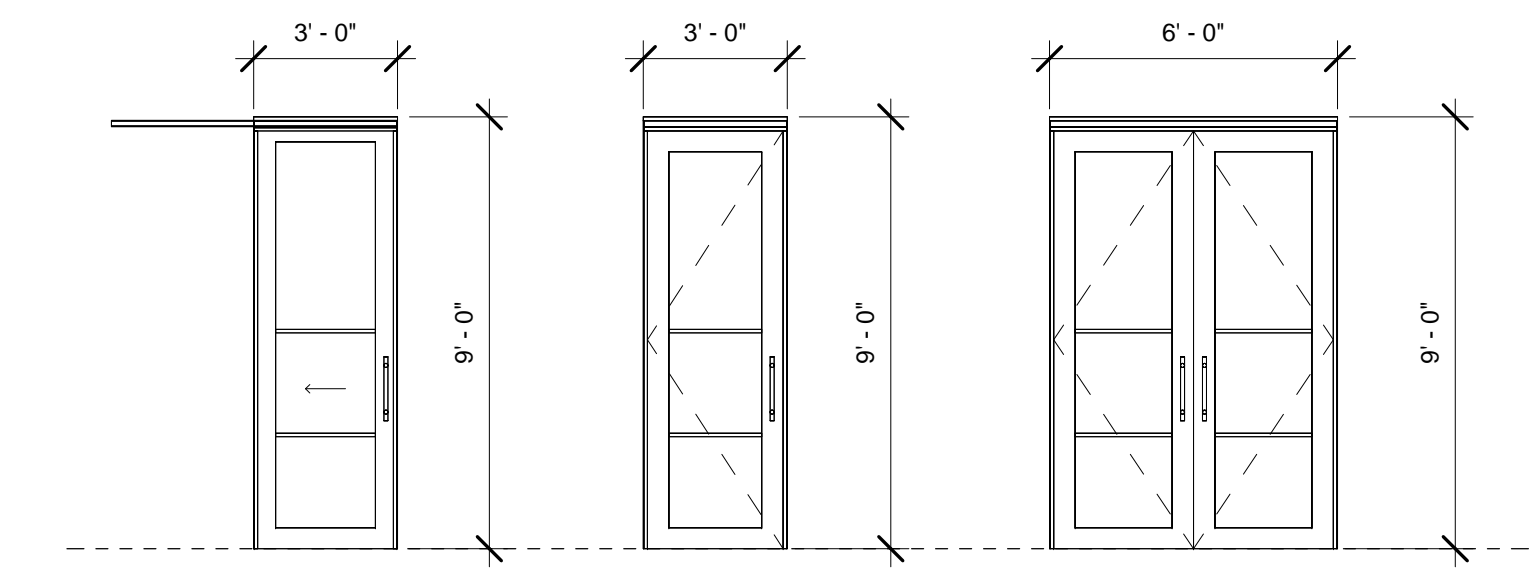CONVENTIONAL DOORS

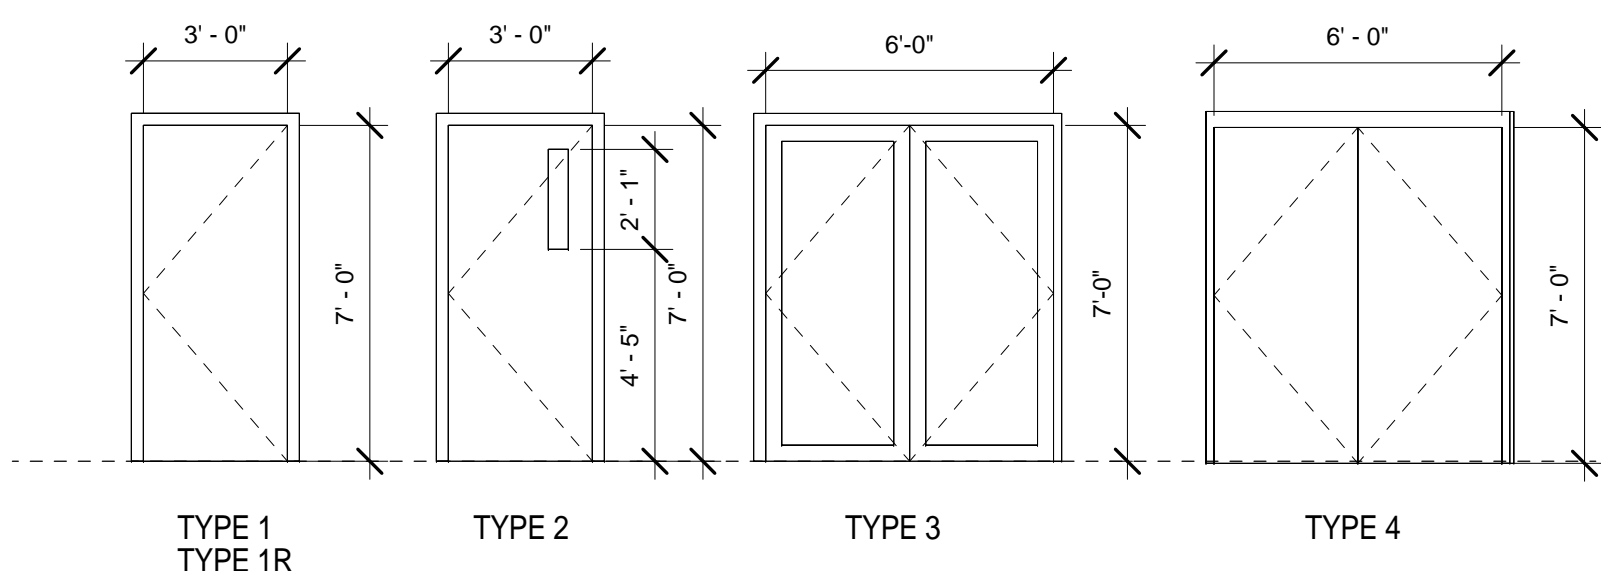DOOR TYPES
1/4" = 1'-0"

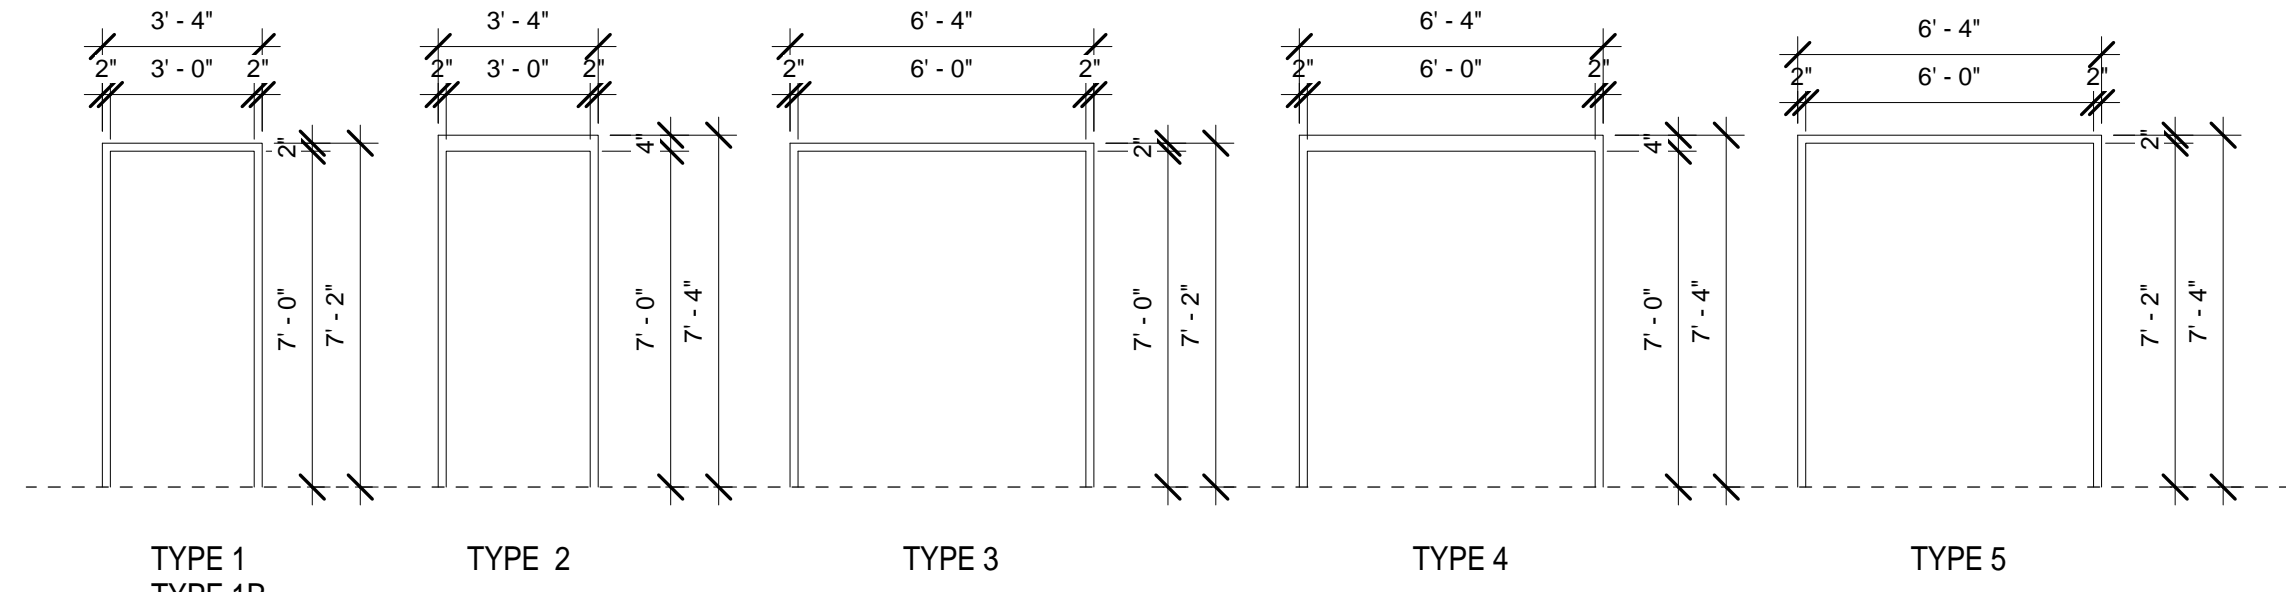

FRAME TYPES
1/4" = 1'-0"

DESIGN BY: [Blank]
 DRAWN BY: [Blank]
 CHECKED BY: [Blank]
 DATE: 2013
 SOLICITATION NO.: [Blank]
 CONTRACT NO.: [Blank]
 FILE NUMBER: [Blank]
 PLOT DATE: 8/26/2014 1:47:35 PM
 PLOT SCALE: 1/4" = 1'-0"
 FILE NAME: [Blank]
 SIZE: 22" x 34"

GENERAL PURPOSE WAREHOUSE
 PROTOTYPE DESIGN
 65,000 SQUARE FOOT VERSION
DOOR SCHEDULE


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A2-602
 SHEET OF 0

DATE	DESCRIPTION	APPR.


DESIGN BY: K. Pope	DESIGNED BY: K. Pope	DATE: 2/13/2013
CHECKED BY: K. Pope	PROJECT NO.:	CONTRACT NO.:
START DATE: 8/26/2014	FILE NUMBER:	
AS INDICATED	FILE NAME:	
22" x 34"		

**GENERAL PURPOSE WAREHOUSE
PROTOTYPE DESIGN
65,000 SQUARE FOOT VERSION
INTERIOR DETAILS**


**SHEET IDENTIFICATION
A2-606**
SHEET OF 0

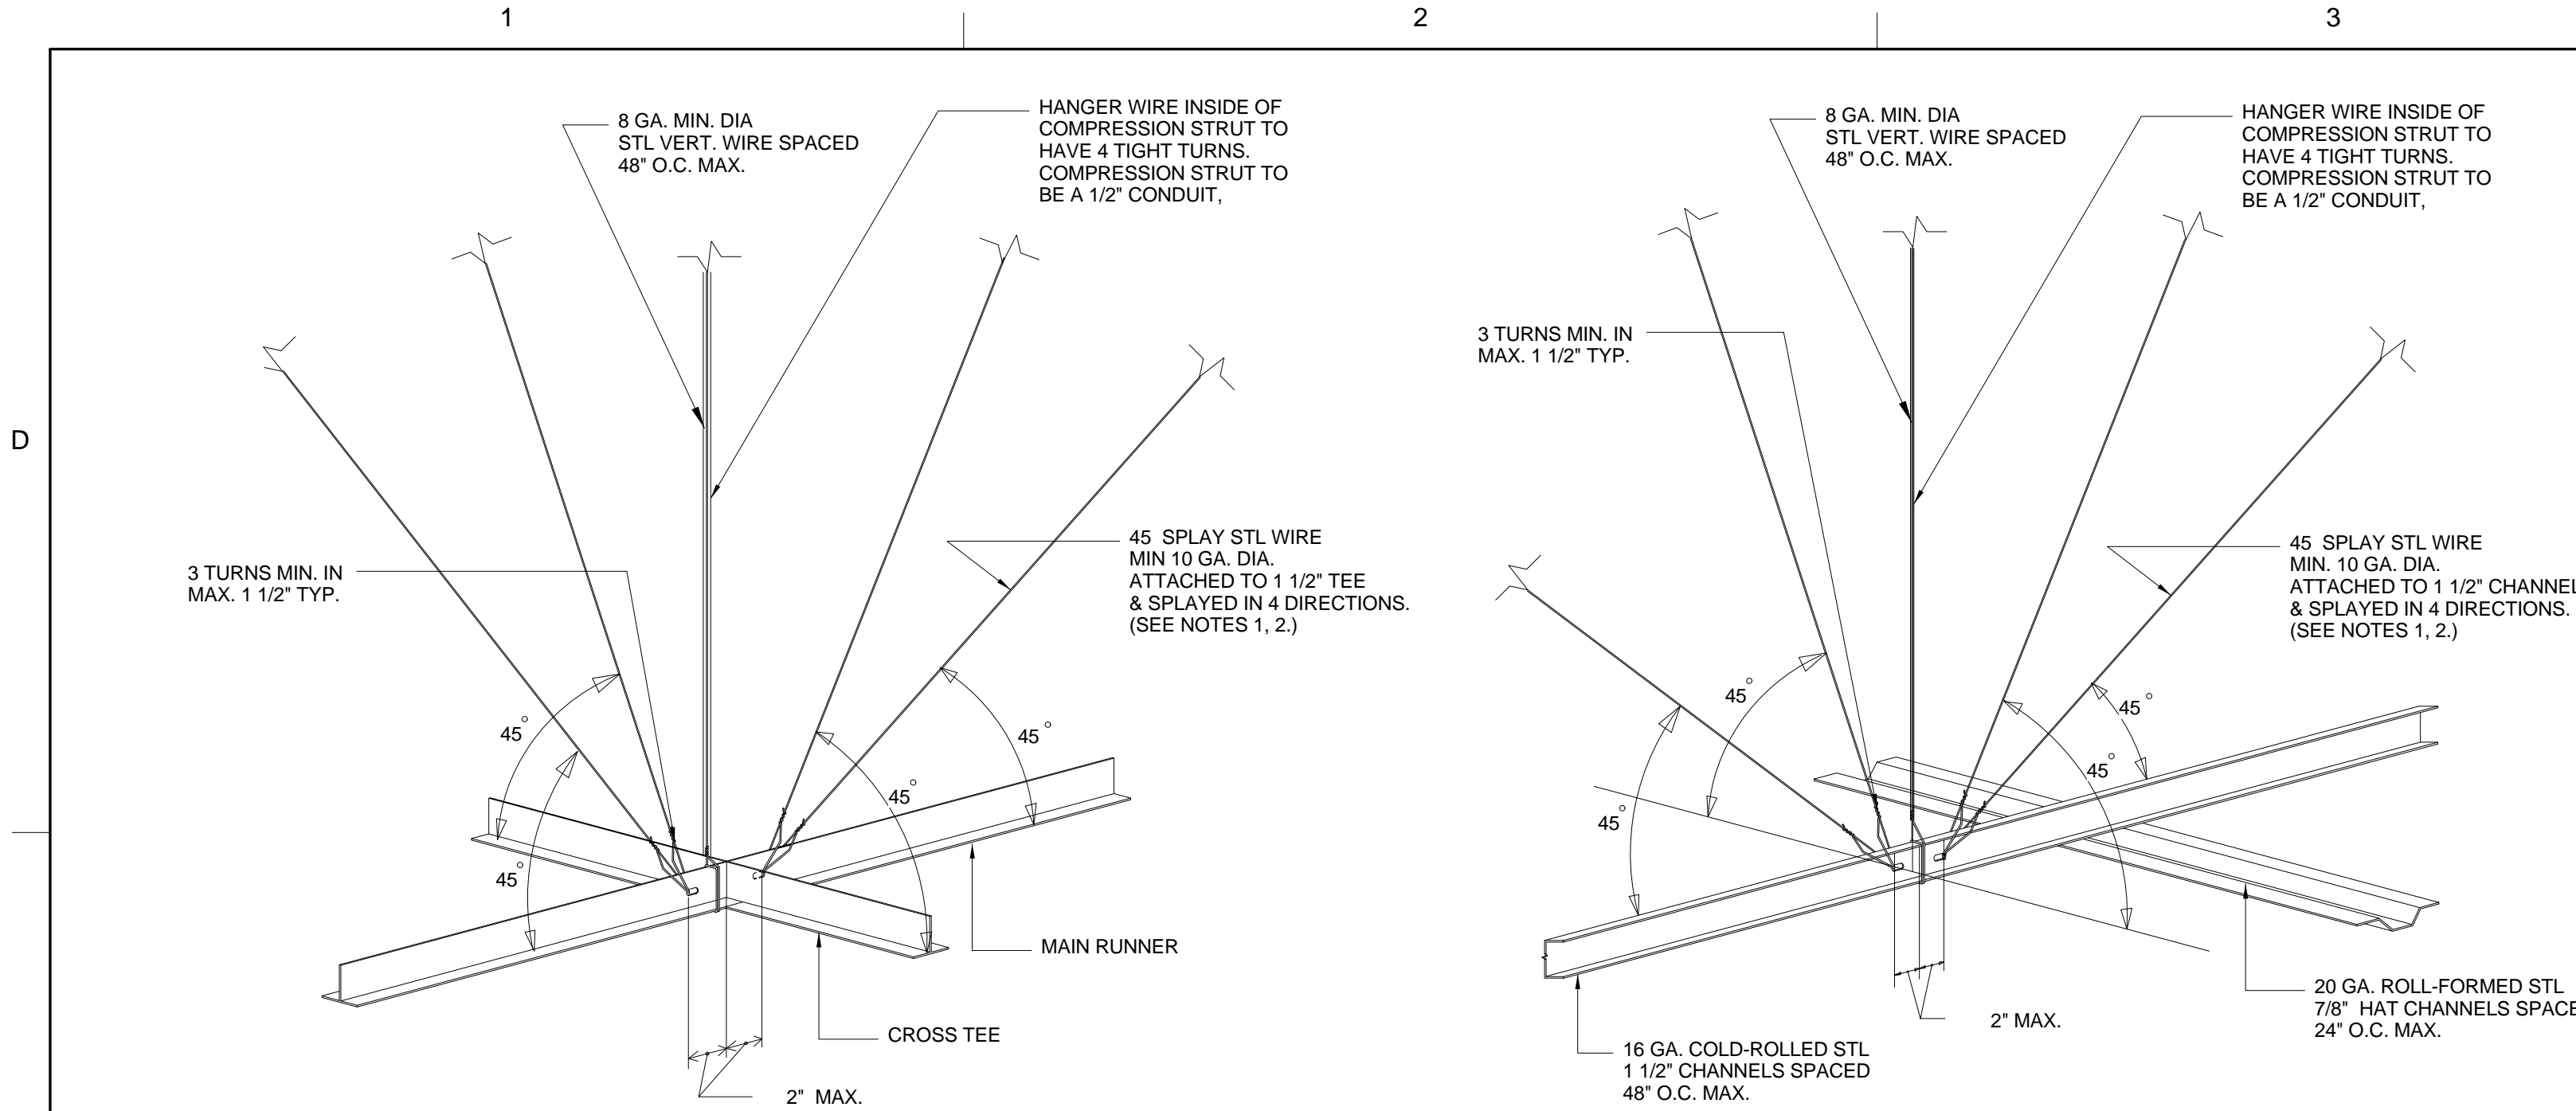

TYPICAL LATERAL BRACING DETAIL FOR SUSPENDED ACOUSTICAL CEILING SYSTEM
3 CEILING BRACE
1/8" = 1'-0"

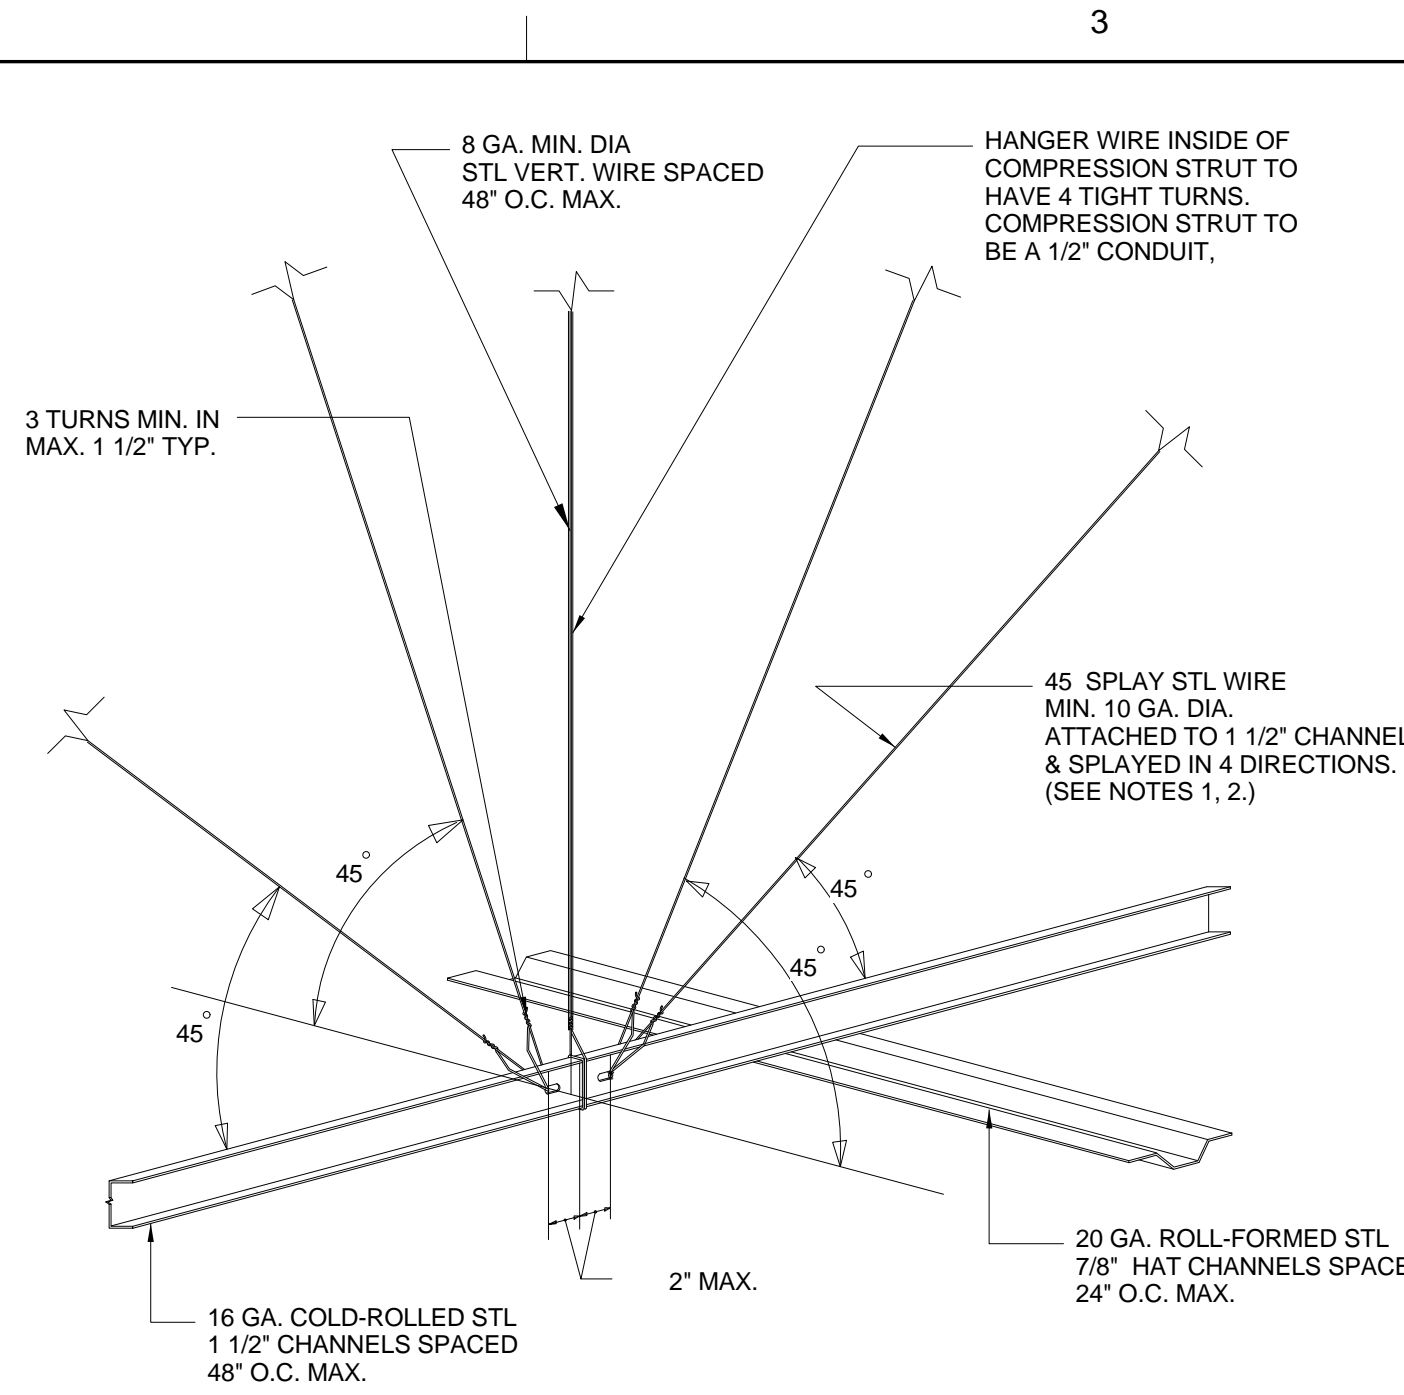


TYPICAL LATERAL BRACING DETAIL FOR SUSPENDED GYPSUM BOARD CEILING SYSTEM
2 CEILING BRACE
1/8" = 1'-0"

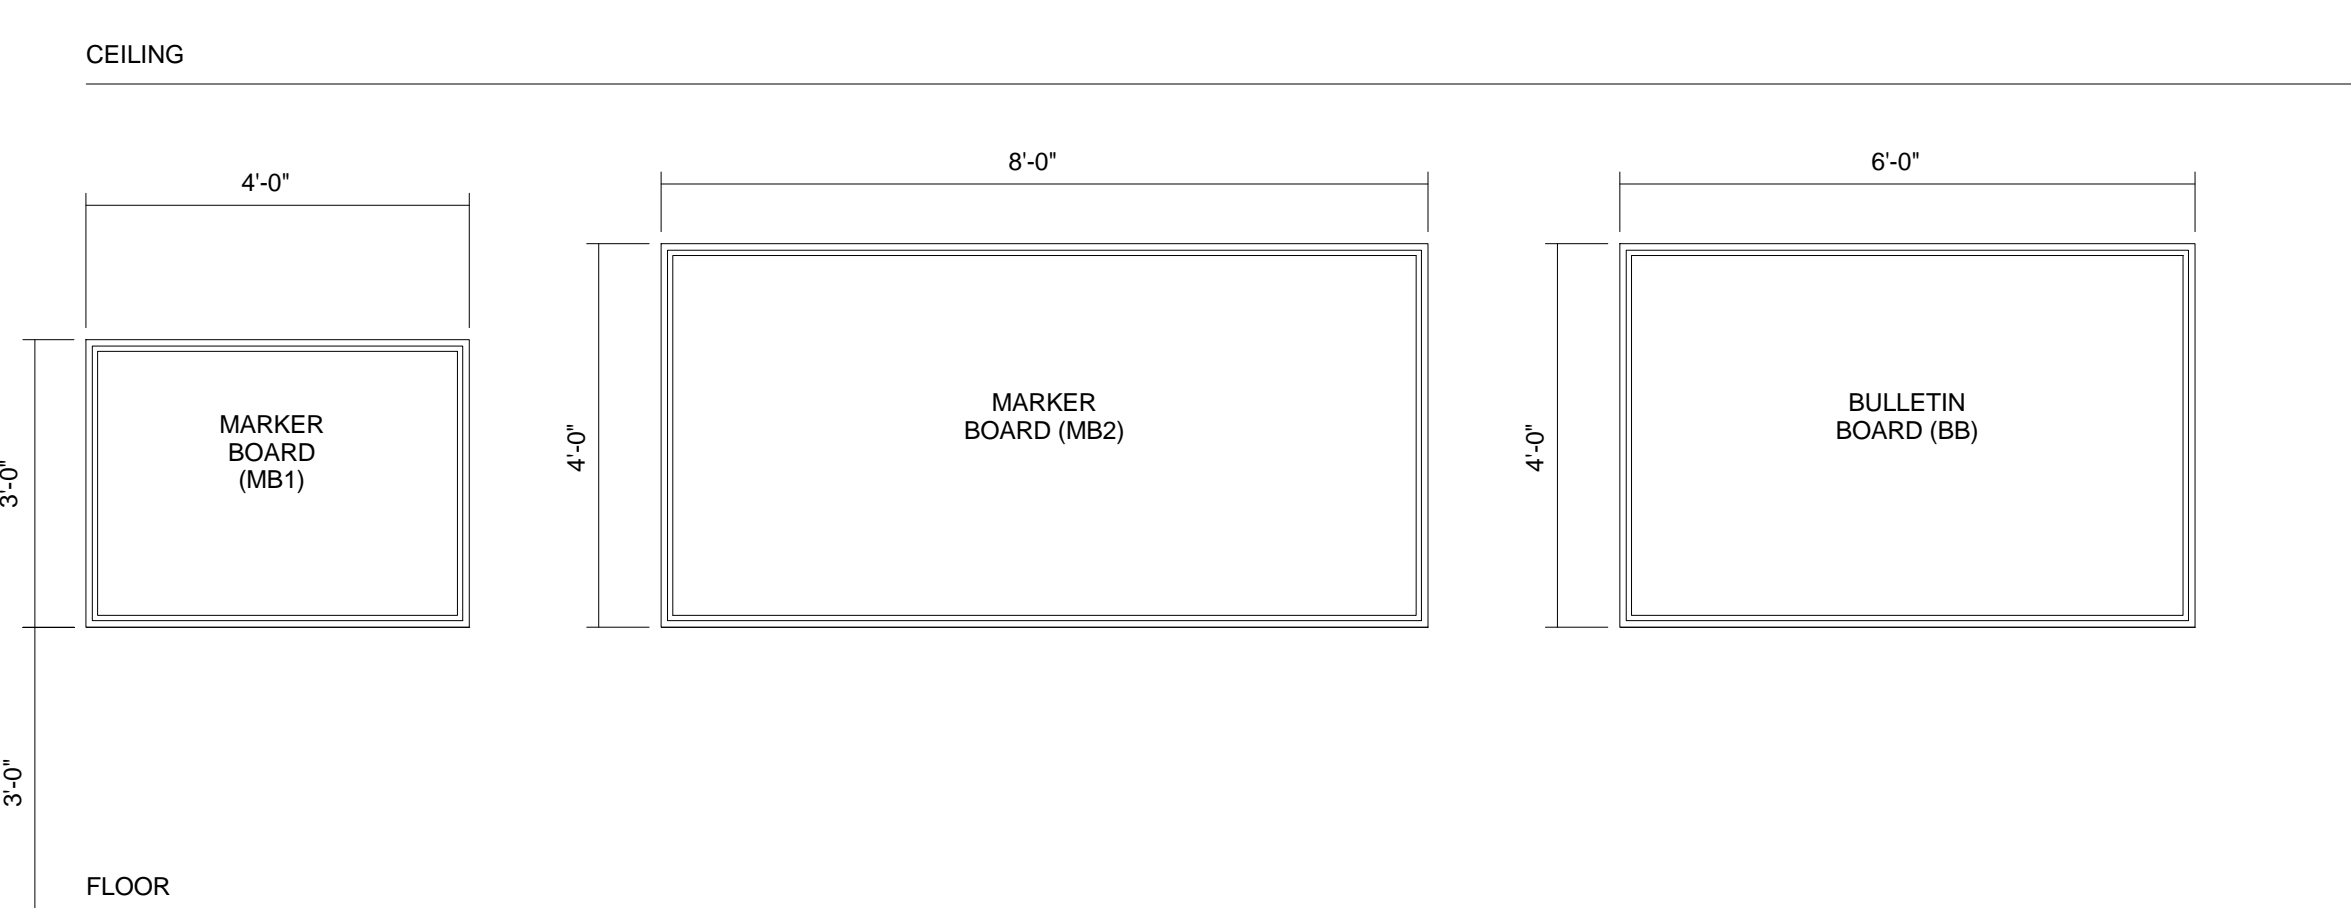


6 BOARD ELEVATIONS
1 1/2" = 1'-0"


NOTES:
1. MOUNTING HEIGHT OF ALL BULLETIN BOARDS AND MARKER BOARDS SHALL BE AS SHOWN.
2. CENTER BULLETIN BOARD / MARKER BOARD ON WALLS AS INDICATED ON FLOOR PLAN PLATES.
3. COORDINATE FINAL PLACEMENT OF MARKER BOARDS IN STAFF OFFICES WITH USER.

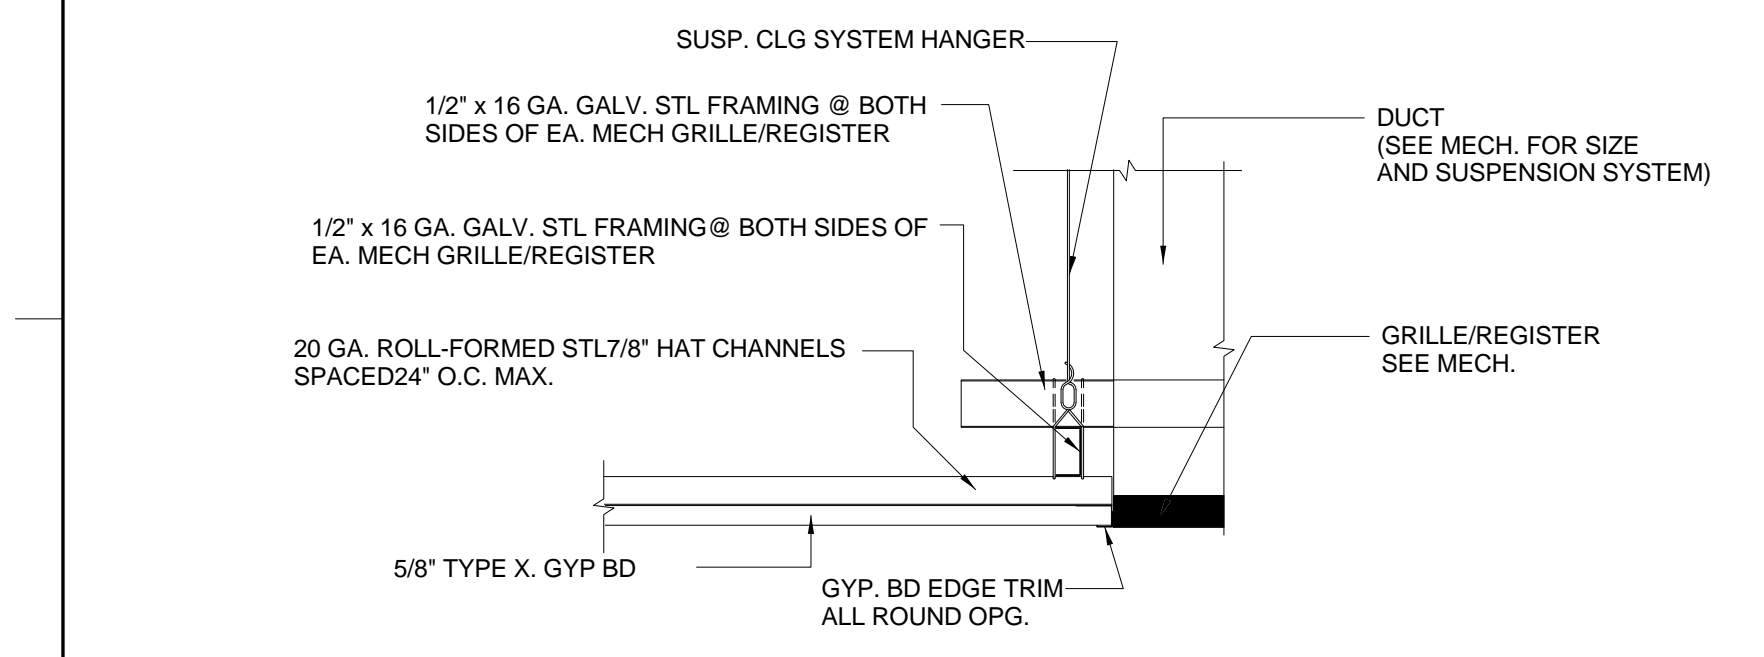

SUSPENDED GYPSUM BOARD CEILING AT MECHANICAL GRILLE/REGISTER DETAIL
4 CEILING DETAIL
1/8" = 1'-0"

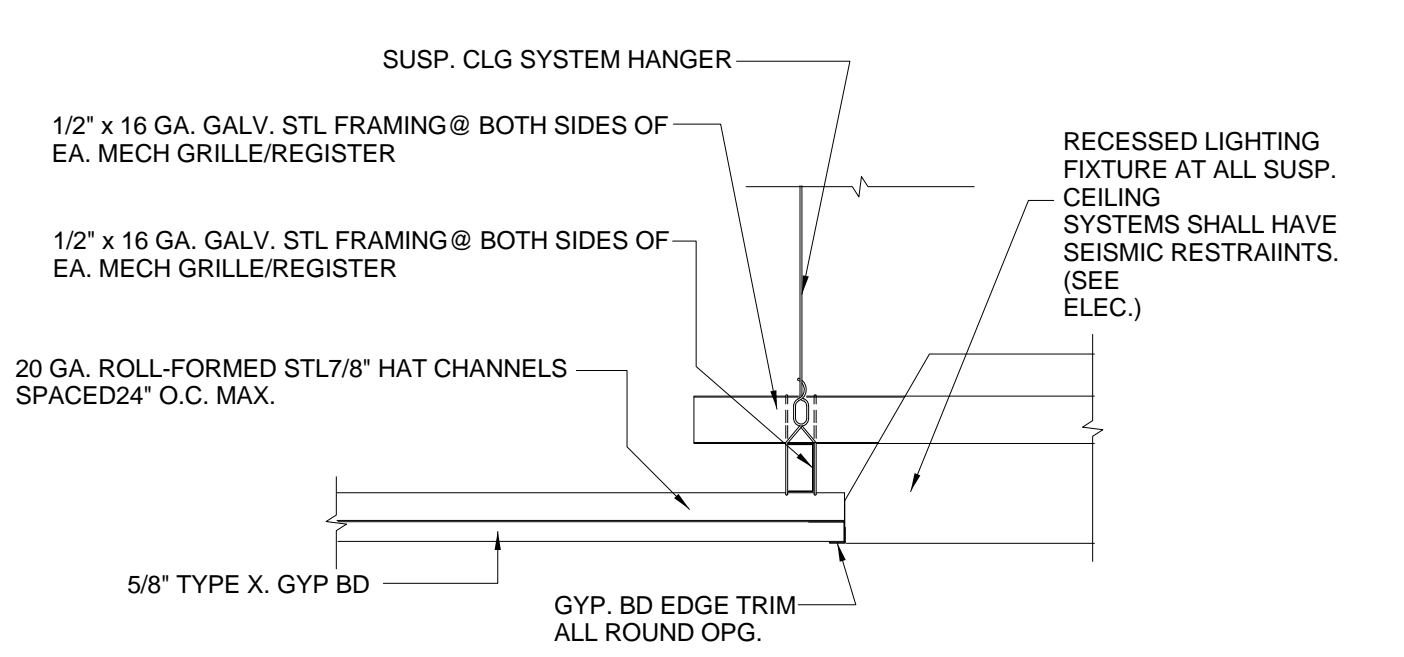


SUSPENDED GYPSUM BOARD CEILING AT LIGHTING FIXTURE DETAIL
5 CEILING DETAIL
1/8" = 1'-0"

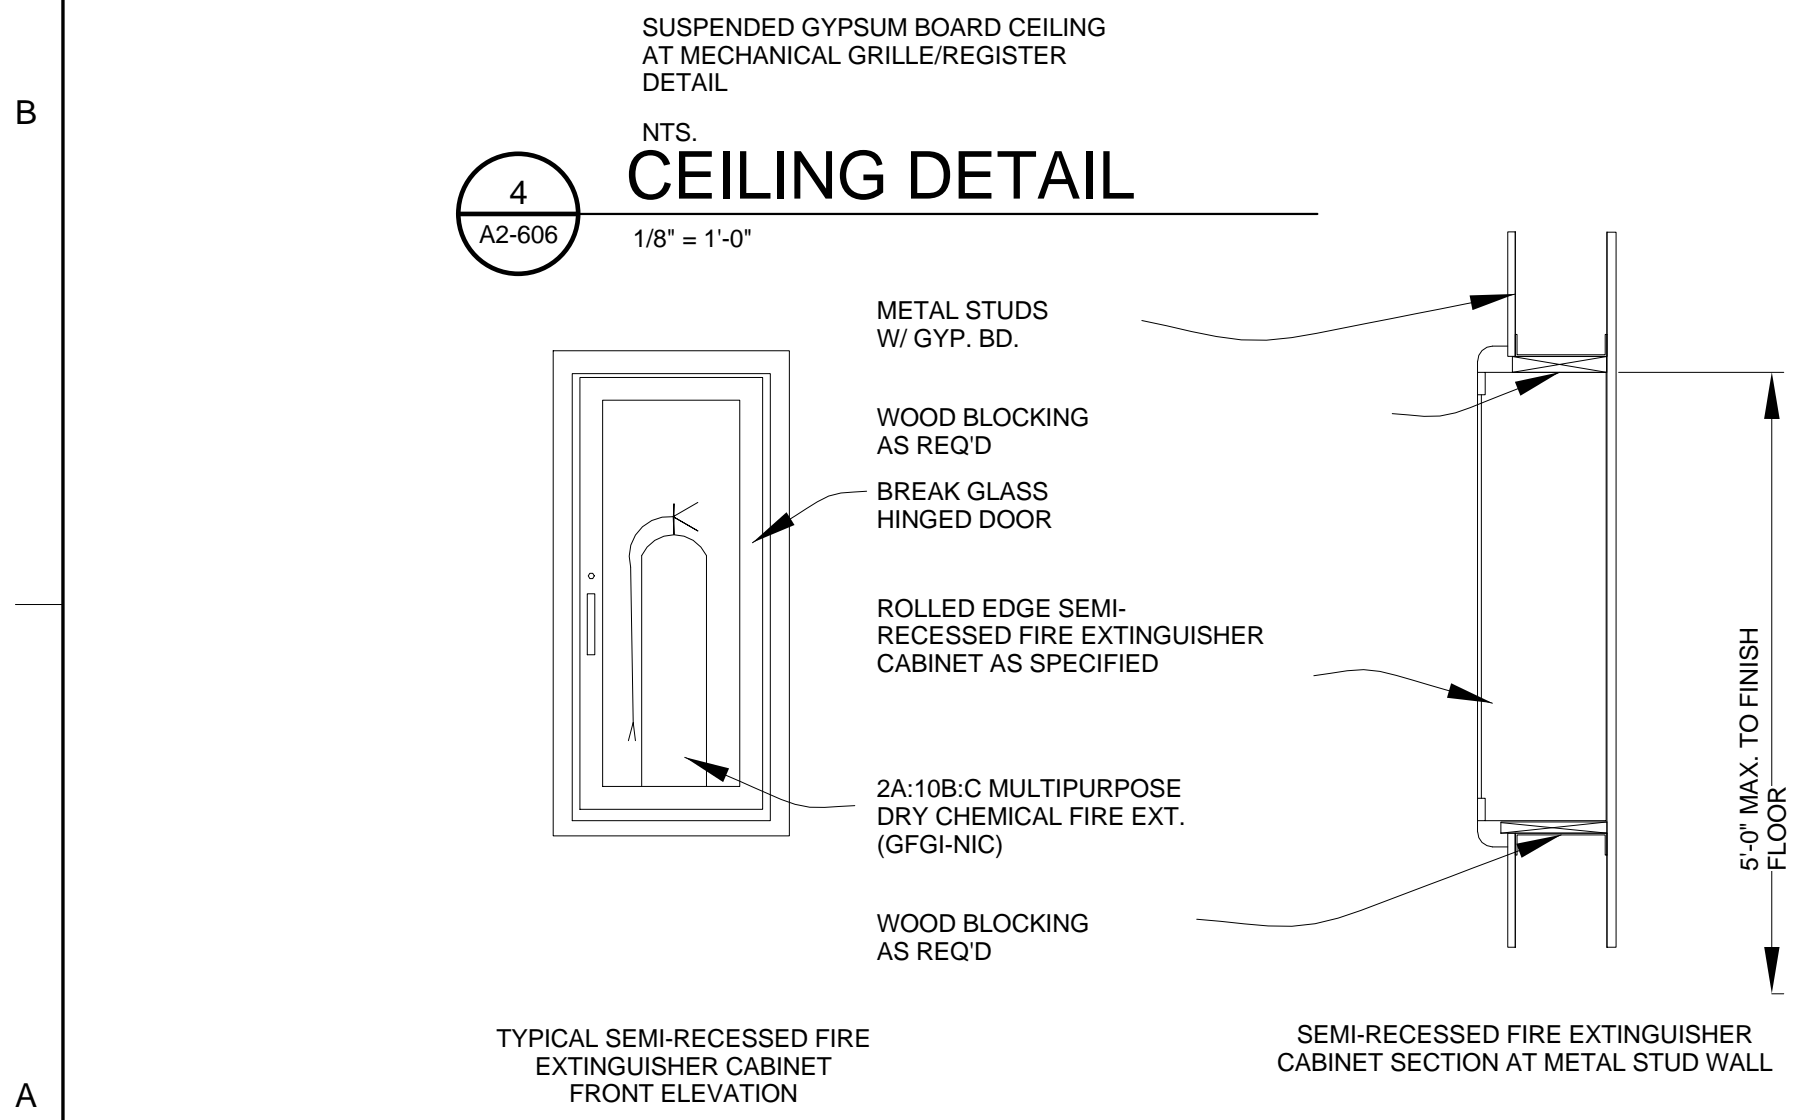

TYPICAL SEMI-RECESSED FIRE EXTINGUISHER CABINET FRONT ELEVATION
SEMI-RECESSED FIRE EXTINGUISHER CABINET SECTION AT METAL STUD WALL
7 F.E. CABINET
1 1/2" = 1'-0"

NOTES:
1. CABINETS SHALL BE SIZED TO ACCOMMODATE GFGI FIRE EXTINGUISHERS. COORDINATE WITH CONTRACTING OFFICER.
2. CABINET SHALL BE LOCKABLE.
3. AT ALL FEB LOCATIONS, BRACKET SHALL BE WALL MOUNTED AT 5'-0" A.F.F. -FIRE EXTINGUISHER TO BE 2A-10B:C (GFGI, NIC)

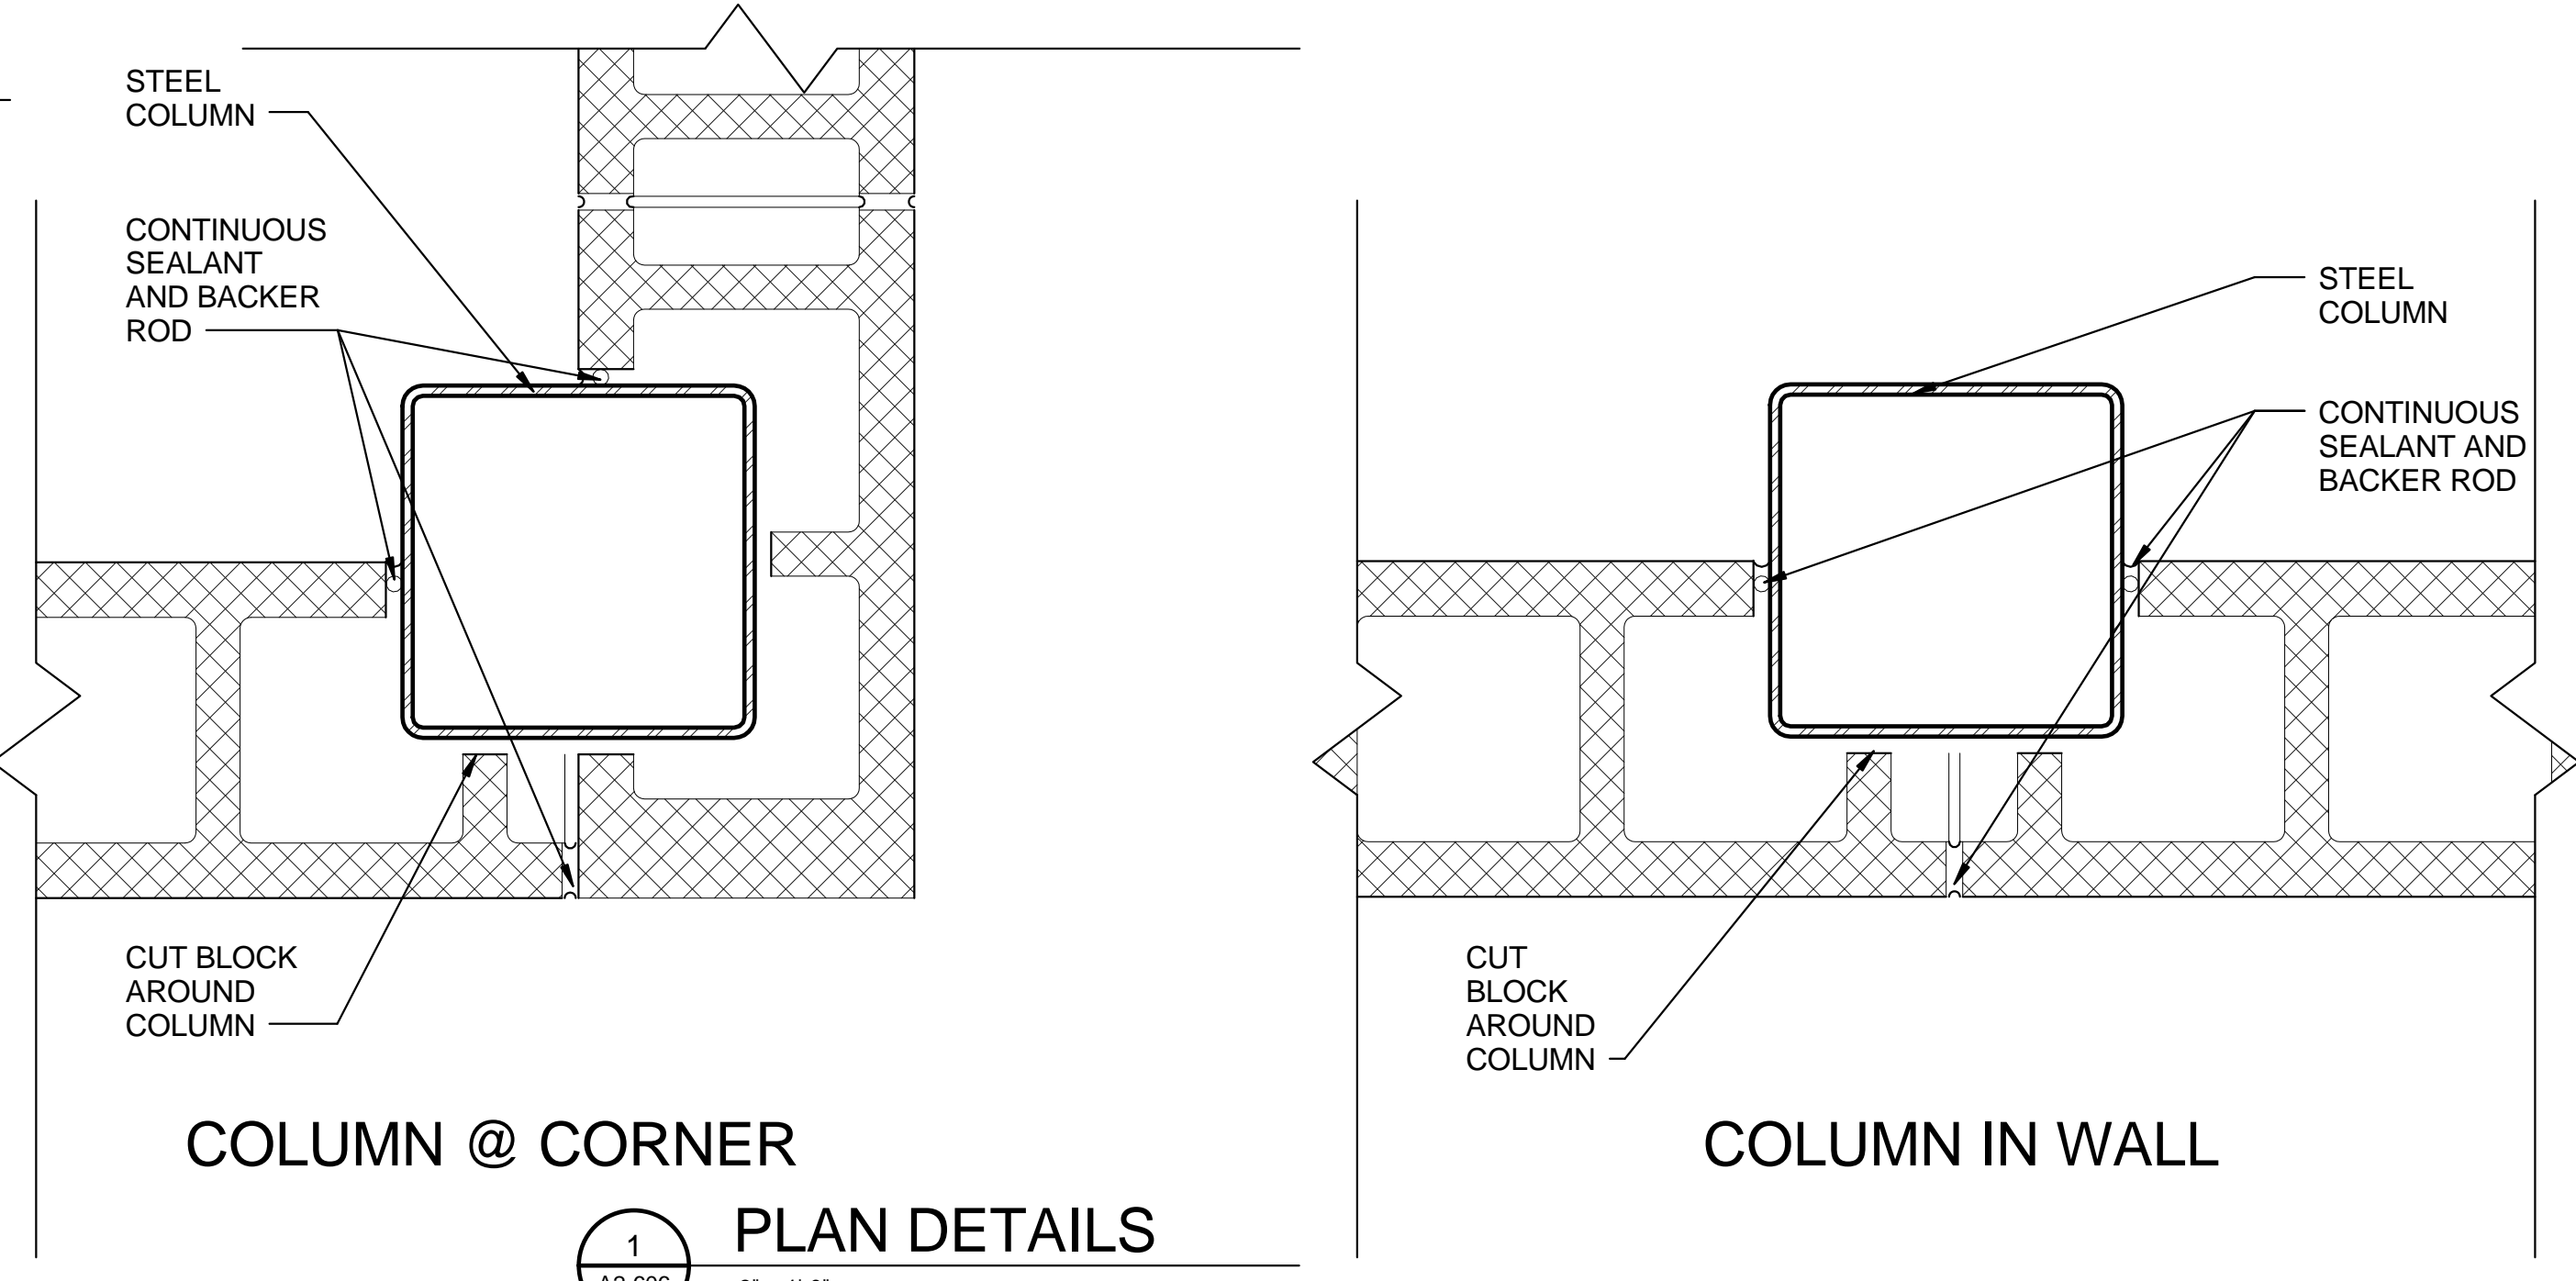

1 PLAN DETAILS
3" = 1'-0"